Attachment A2.4

Plans

SUMMARY OF QUANTITIES			SUMMARY OF QUANTITIES		
ITEM DESCRIPTION	UNIT	QUANTITY	ITEM DESCRIPTION UNIT	QUANTITY	
BRIDGE PLAQUE	EA.	1 **	REMOVAL OF EXISTING SIGNING L.S.	1	
EARTH EXCAVATION	C.Y.	100	SIGN FACE - SHEET ALUMINUM (TYPE III REFLECTIVE SHEETING) S.F.	40	
ROCK EXCAVATION CHANNEL EXCAVATION-EARTH	C.Y. C.Y.	15 800	ORNAMENTAL SIGN POSTEA.PAINTED PAVEMENT MARKINGS (4") (WHITE)L.F.	725	
REMOVAL OF GRANITE STONE CURBING	L.F.	485	PAINTED PAVEMENT MARKINGS (4") (YELLOW)	1120	
CUT BITUMINOUS CONCRETE PAVEMENT	L.F.	225	PAINTED PAVEMENT MARKINGS (12'') (WHITE) L.F.	260	
COFFERDAM AND DEWATERING	LF	1250	PAINTED LEGEND, ARROWS AND MARKINGS S.F.	1400	
ROCK IN TRENCH EXCAVATION 0'-10' DEEP PROCESSED AGGREGATE BASE	C.Y. C.Y.	150	REMOVAL OF PAINTED PAVEMENT MARKINGSS.F.TEMPORARY PLASTIC PAVEMENT MARKING TAPE (4'') (YELLOW)L.F.	180 600	
BRICK PAVING	S.F.	7600 **		620	
HMA SO.5	TON	130	TEMPORARY PLASTIC PAVEMENT MARKING TAPE (12'') (WHITE) L.F.	30	
HMA S0.375	TON	80	TEMPORARY PLASTIC LEGEND ARROWS AND MARKINGS S.F.	175	
MATERIAL FOR TACK COAT MILLING OF HOT MIX ASPHALT (HMA) - 0-4 INCHES	GAL. S.Y.	145 925	CONSTRUCTION SIGNS (TYPE III REFLECTIVE SHEETING)S.F.TEMPORARY SUPPORT FOR EXISTING TELEPHONE DUCTSL.S.	400	
TYPE "C" CATCH BASIN TOP	EA.	925	TEMPORART SUPPORT FOR EXISTING TELEPHONE DUCTS	2	
TYPE ''C'' CATCH BASIN - FRAME AND GRATE	EA.	4	RECOGATION OF TEMPORARY INPACT ATTENDATION SYSTEM TYPE A PRACT		
RESET TYPE ''C'' CATCH BASIN	EA.	4	BLAST CLEAN EXISTING CONCRETE SF	5000 **	
POLYVINYL CHLORIDE PLASTIC PIPE WEEPHOLES	EA,	5	hummun	mm	
CONSTRUCT WEEP DRAINS PRECAST CONCRETE ARCHITECTURAL PANELS (SITE NO. 1)	EA. L.S.	9	* A SUM HAS BEEN INSERTED FOR BIDDING PURPOSES, HOWEVER THIS ITEM IS TO E	RE PAIN	
VARIABLE DEPTH PATCH	C.F.	5000	BY THE ACTUAL COST AS DESCRIBED IN THE SPECIFICATIONS.		
CLASS ''F'' CONCRETE	C.Y.	450			
LIGHTWEIGHT CONCRETE	C.Y.	400 **	** TOWN MAY CONSIDER ELIMINATING THESE ITEMS FROM THE CONTRACT OR USING (FOR THIS WORK AT THEIR DISCRETION, NO COMPENSATION WILL BE MADE TO THE		
ASPHALTIC PLUG EXPANSION JOINT SYSTEM	L.F.	80	ELIMINATING THESE ITEMS.	E CONTRACTOR	
DEFORMED STEEL BARS DEFORMED STEEL BARS-EPOXY COATED	LB, LB,	13000 35000			
DOWEL BAR SPLICER SYSTEM	EA,	4700	NOTE: THIS IS A REHABILITATION PROJECT AND QUANTITIES MAY VARY SIGNIFICANTLY FROM THOSE SHOWN ON THE PLANS. THE CONTRACTOR WILL BE PAID FOR THE ACTUAL QUANTITY OF ITEMS INSTALLED. NO ADJUSTMENT IN UNIT PRICES WILL BE MADE FOR QUANTITIES LESS THAN OR EXCEEDING THOSE SHOWN.		
DRILLING HOLES AND GROUTING DOWELS	EA	550			
SPECIAL PAINTING TREATMENT	S.F.	3200 **			
TEMPORARY SLAB SUPPORT	L.F.	400			
DIMENSION STONE MASONRY REPOINT MORTAR JOINTS	S.Y. L <i>.</i> F.	3 700			
ROUNDED STONE RIPRAP	C.Y.	800			
MEMBRANE WATERPROOFING (WOVEN GLASS FABRIC)	S.Y.	850			
GEOTEXTILE	S.Y.	400			
CONCRETE CURBING 5" GRANITE STONE CURBING	L <i>.</i> F.	20			
5'' GRANITE CURVED STONE CURBING	L <i>.</i> F.	52			
RESET GRANITE STONE CURBING	L.F.	15			
TEMPORARY PRECAST CONCRETE BARRIER CURB	L <i>.</i> F.	150			
TEMPORARY PRECAST CONCRETE BARRIER CURB (STRUCTURE)	L <i>.</i> F.	180			
RELOCATED TEMPORARY PRECAST CONCRETE BARRIER CURB (STRUCTURE) REMOVAL OF EXISTING METAL BRIDGE RAIL	L <i>.</i> F.	180 360			
CONCRETE SIDEWALK	S.F.	1800			
RETRO-FIT DETECTABLE WARNING STRIP	EA	7			
CONSTRUCTION FIELD OFFICE, SMALL	MO.	20			
TRAFFICPERSON (MUNICIPAL POLICE OFFICER)	EST.	1 *			
MAINTENANCE AND PROTECTION OF TRAFFIC REMOVAL OF EXISTING MASONRY	L.S. C.Y.	750			
MOBILIZATION	L.S.	1			
TRAFFIC DRUM	EA.	30			
CONSTRUCTION BARRICADE TYPE III	EA.	15			
DISPOSAL OF BUILDINGS	L.S.	1 **			
TRENCHING AND BACKFILLING (TYPE I) TRENCHING AND BACKFILLING (TYPE II)	L <i>.</i> F.	670 125			
TRENCHING AND BACKFILLING (TYPE II)	L <i>.</i> F.	125			
REMOVE LIGHT STANDARD	EA.	2			
4" POLYVINYL CHLORIDE CONDUIT IN STRUCTURE	L <i>.</i> F.	380			
4" POLYVINYL CHLORIDE CONDUIT UNDER ROADWAY	L.F.	950			
5" POLYVINYL CHLORIDE CONDUIT UNDER ROADWAY	L <i>.</i> F.	1110			
2" RIGID METAL CONDUIT UNDER ROADWAY 2" RIGID METAL CONDUIT IN STRUCTURE	L <i>.</i> F.	155 340			
5" FIBERGLASS CONDUIT IN STRUCTURE	L <i>.</i> F.	1520			
8''X 8''X 8''CAST IRON JUNCTION BOX	EA.	4			
INSTALL PRECAST CONCRETE MANHOLE	EA.	2			
TEMPORARY SIGNALIZATION (SITE 1)	L.S.	1			

					DESIGNER/DRAFTER:	CDU
				THE INFORMATION, INCLUDING ESTIMATED		CRH
				QUANTITIES OF WORK, SHOWN ON THESE SHEETS IS BASED ON LIMITED	CHECKED BY:	RIE
				INVESTIGATIONS BY THE STATE AND IS IN NO WAY WARRANTED TO INDICATE		INJI
				THE CONDITIONS OF ACTUAL QUANTITIES OF WORK WHICH WILL BE REQUIRED.		
				OF WORK WHICH WILL BE REQUIRED.	SCALE AS NOTED	
1	6/22/12	REVISED QUANTITIES				
REV.	DATE	REVISION DESCRIPTION	SHEET NO.	Platted Date: 6/22/2012		

GENERAL NOTES:

- THE CONTRACT DOCUMENTS.
- WWW.CT.GOV/DOT.
- 3. DATUM: HORIZONTAL CONTROL NAD 83 VERTICAL CONTROL - NAVD 88
- 4. DESIGN SPEED: 25 MPH.

- "STRUCTURE EXCAVATION EARTH" ITEM.
- CONSIDERED INCIDENTAL

- UTILITIES

AT&T (TELEPHONE) TOM DELORENZO (203) 238-5202 OR GLEN MCCLOUD (203) 575-6703

YANKEE GAS (GAS) ROB PANTALONE (203) 596-3020







1. DESIGN SPECIFICATIONS: ALL ROAD, DRAINAGE AND STRUCTURAL WORK (AND APPURTENANT WORK) SHALL BE PERFORMED IN ACCORDANCE WITH THE TECHNICAL REQUIREMENTS, INCLUDING MATERIALS AND METHODS, OF THE STATE OF CONNECTICUT DEPARTMENT OF TRANSPORTATION STANDARD SPECIFICATIONS FOR ROADS, BRIDGES AND INCIDENTAL CONSTRUCTION, FORM 816, 2004 (INCLUDING ADDENDUMS AND SUPPLEMENTALS) UNLESS OTHERWISE SPECIFIED IN

2. CTDOT STANDARD SHEETS: THE CONTRACTOR IS RESPONSIBLE FOR OBTAINING THE CONNECTICUT DEPARTMENT OF TRANSPORTATION (CTDOT) STANDARD SHEETS LISTED ON THE TITLE SHEET. THESE SHEETS CAN BE OBTAINED DIRECTLY FROM THE DEPARTMENT AND/OR DOWNLOADED FROM THE DEPARTMENT'S WEBSITE AT

5. MUTCD: ALL PERMANENT AND TEMPORARY TRAFFIC CONTROL DEVICES INCLUDING TRAFFIC SIGNS, CONSTRUCTION SIGNS, , A PAVEMENT MARKINGS, AND CHANNELIZATION DEVICES SHALL MEET THE REQUIREMENTS OF, AND BE INSTALLED/PLACED IN ACCORDANCE WITH, THE DIMENSIONS AND LOCATIONS SPECIFIED IN THE 2009 EDITION OF THE MANUAL ON UNIFORM TRAFFIC CONTROL DEVICES (MUTCD), AS INDICATED ON THE PLANS, OR AS DIRECTED BY THE ENGINEER.

6. REMOVED MATERIALS: THE BOROUGH OF NAUGATUCK WILL BE PROVIDED THE OPTION OF RETAINING THE POSSESSION OF ALL MATERIALS REMOVED OR EXCAVATED IN THE COURSE OF EXECUTING THIS PROJECT. ANY MATERIALS RETAINED FOR BY THE BOROUGH SHALL BE DELIVERED TO A SITE WITHIN BOROUGH LIMITS AS DESIGNATED BY THE BOROUGH AT NO ADDITIONAL COST TO THE BOROUGH OF NAUGATUCK. ALL MATERIALS NOT RETAINED BY THE BOROUGH SHALL BE PROPERLY DISPOSED OF AT NO ADDITIONAL COST TO THE BOROUGH OF NAUGATUCK.

7. EXCAVATED MATERIALS: ANY EXCAVATED MATERIALS DEEMED BY THE ENGINEER AS BEING SUITABLE FOR RE-USE SHALL BE STOCKPILED ON THE JOB SITE AS DIRECTED BY THE ENGINEER FOR FUTURE USE AS BACKFILL. NO ADDITIONAL PAYMENT WILL BE MADE FOR STOCKPILING MATERIAL, FOR RE-USE AS BACKFILL, OR FOR THE REMOVAL OF SURPLUS STOCKPILED MATERIAL NOT UTILIZED ON THE PROJECT. THE COST OF STOCKPILING IS TO BE INCLUDED IN THE

8. PAY ITEMS: TECHNICAL SPECIFICATIONS SHALL BE IN ACCORDANCE WITH STATE OF CONNECTICUT FORM 816 (SEE NOTE 1). SOME OF THESE TECHNICAL ITEMS HAVE BEEN COMBINED FOR PAYMENT PURPOSES, AND THEREFORE, PAYMENT WILL ONLY BE MADE ACCORDING TO THE PAY ITEMS LISTED IN THE BID DOCUMENT FORMS PROVIDED. ALL MATERIALS, TOOLS, EQUIPMENT AND LABOR REQUIRED TO COMPLETE THE WORK AS DETAILED ON THESE PLANS SHALL BE INCLUDED IN CONTRACT PAY ITEMS. ANY WORK NOT SPECIFICALLY LABELED BUT NECESSARY TO COMPLETE THE WORK SHALL BE

9. 'CALL BEFORE YOU DIG': EXISTING STORM DRAIN, SANITARY SEWER, GAS, ELECTRIC, TELECOMMUNICATIONS AND OTHER UTILITIES ARE SHOWN IN THEIR APPROXIMATE LOCATIONS ON THE PLANS. THE CONTRACTOR SHALL CONTACT 'CALL BEFORE YOU DIG'AT (800) 922-4455 THREE DAYS PRIOR TO BEGINNING ANY SUBSURFACE CONSTRUCTION ACTIVITIES TO DETERMINE THE LOCATIONS OF THESE AND ANY OTHER BURIED UTILITIES NOT SHOWN ON THE PLANS.

10. DRAINAGE STRUCTURES: STATIONINGS AND TOP OF FRAME (TF) ELEVATIONS ARE MEASURED FROM THE LONGITUDINAL CENTER OF EACH STRUCTURE AT THE FACE OF CURB OR EDGE OF PAVEMENT, WHICHEVER APPLIES.


11. UTILITIES: UTILITY DESIGN HAS BEEN COORDINATED WITH THE RESPECTIVE UTILITY COMPANIES FOR TELEPHONE, GAS, ELECTRIC, AND CABLE. THE CONTRACTOR SHALL UTILIZE THE FOLLOWING CONTACTS WHEN DIRECTED TO CONTACT

> CL&P (ELECTRIC) BRIAN MORGAN (203) 597-4233

COMCAST (CABLE) DAVE GERRISH (203) 732-0146 EXT 73801

12. EXCAVATION: FINAL EXCAVATION LIMITS SHALL BE DETERMINED IN THE FIELD, TO THE APPROVAL OF THE ENGINEER. WHERE PAYMENT IS NOT OTHERWISE SPECIFIED, PAYMENT SHALL BE UNDER THE "EARTH EXCAVATION", "ROCK EXCAVATION" OR "REMOVE EXISTING MASONRY" ITEMS, AS APPROVED BY THE ENGINEER.

APLE STREET	NAUGATUCK	PROJECT NO. 9087-4214	
OVER		DRAWING NO.	
JGATUCK RIVER	GENERAL NOTES AND QUANTITIES	SHEET NO. 2 of 25	

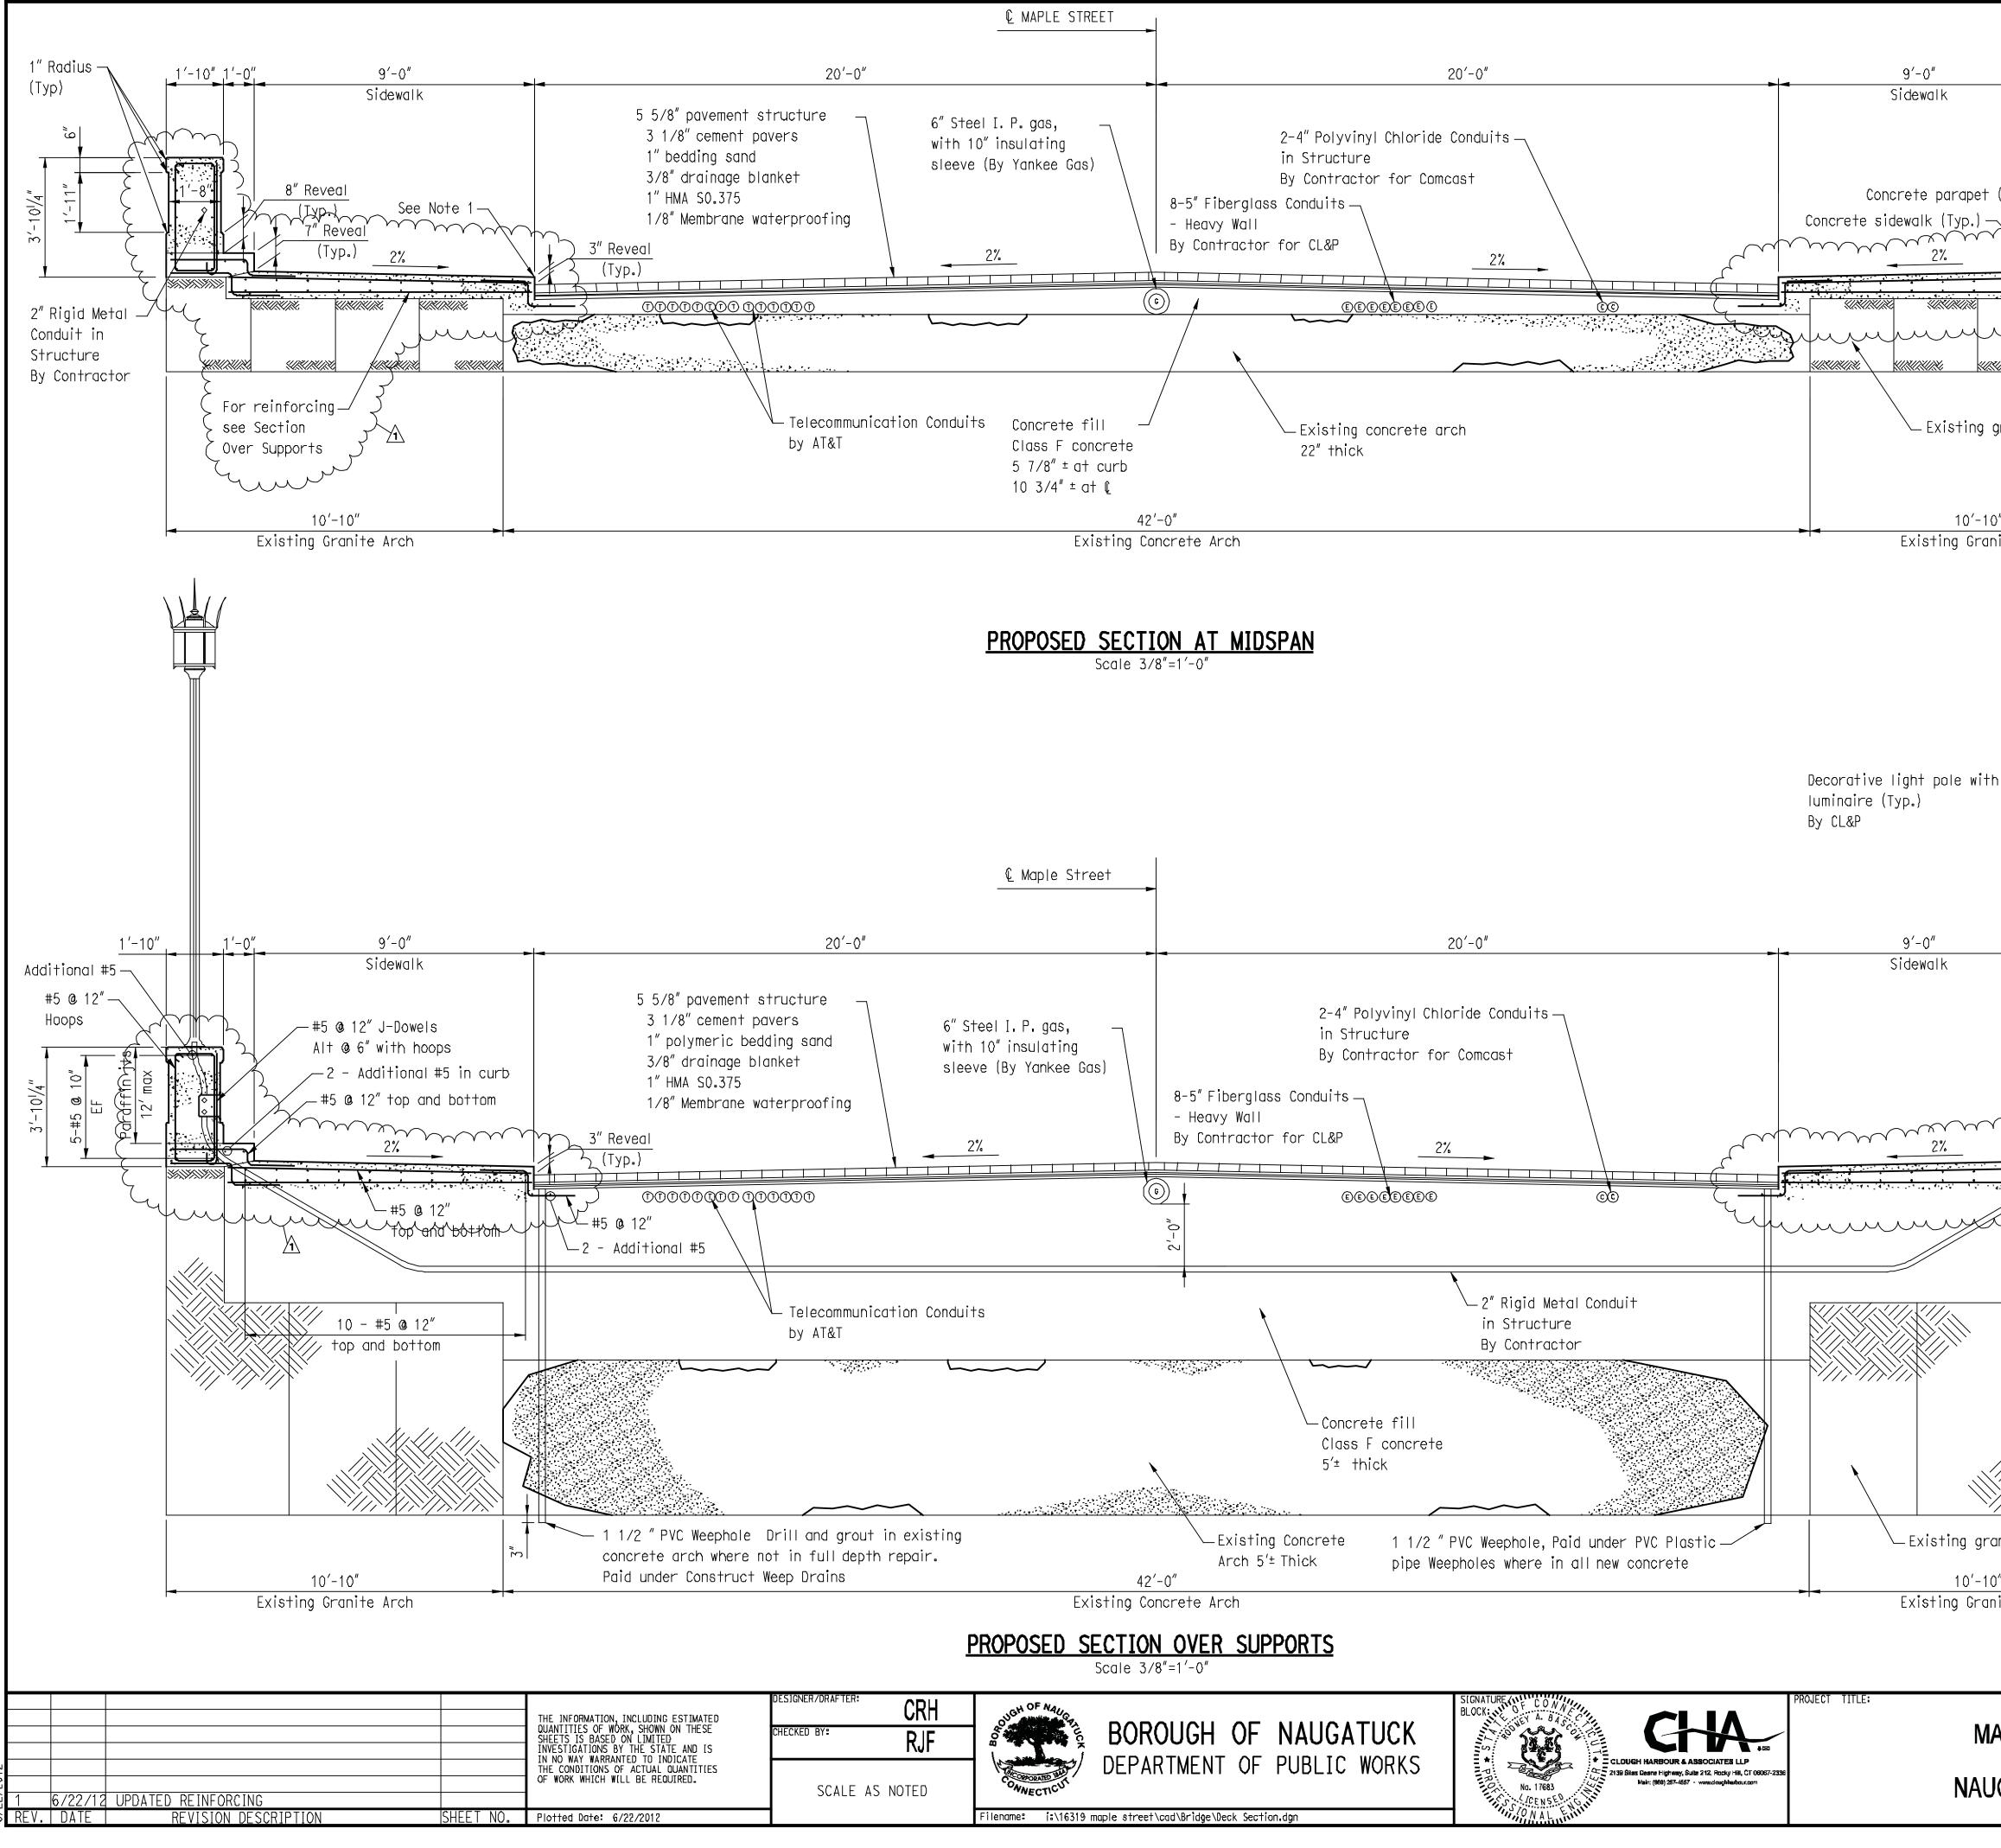


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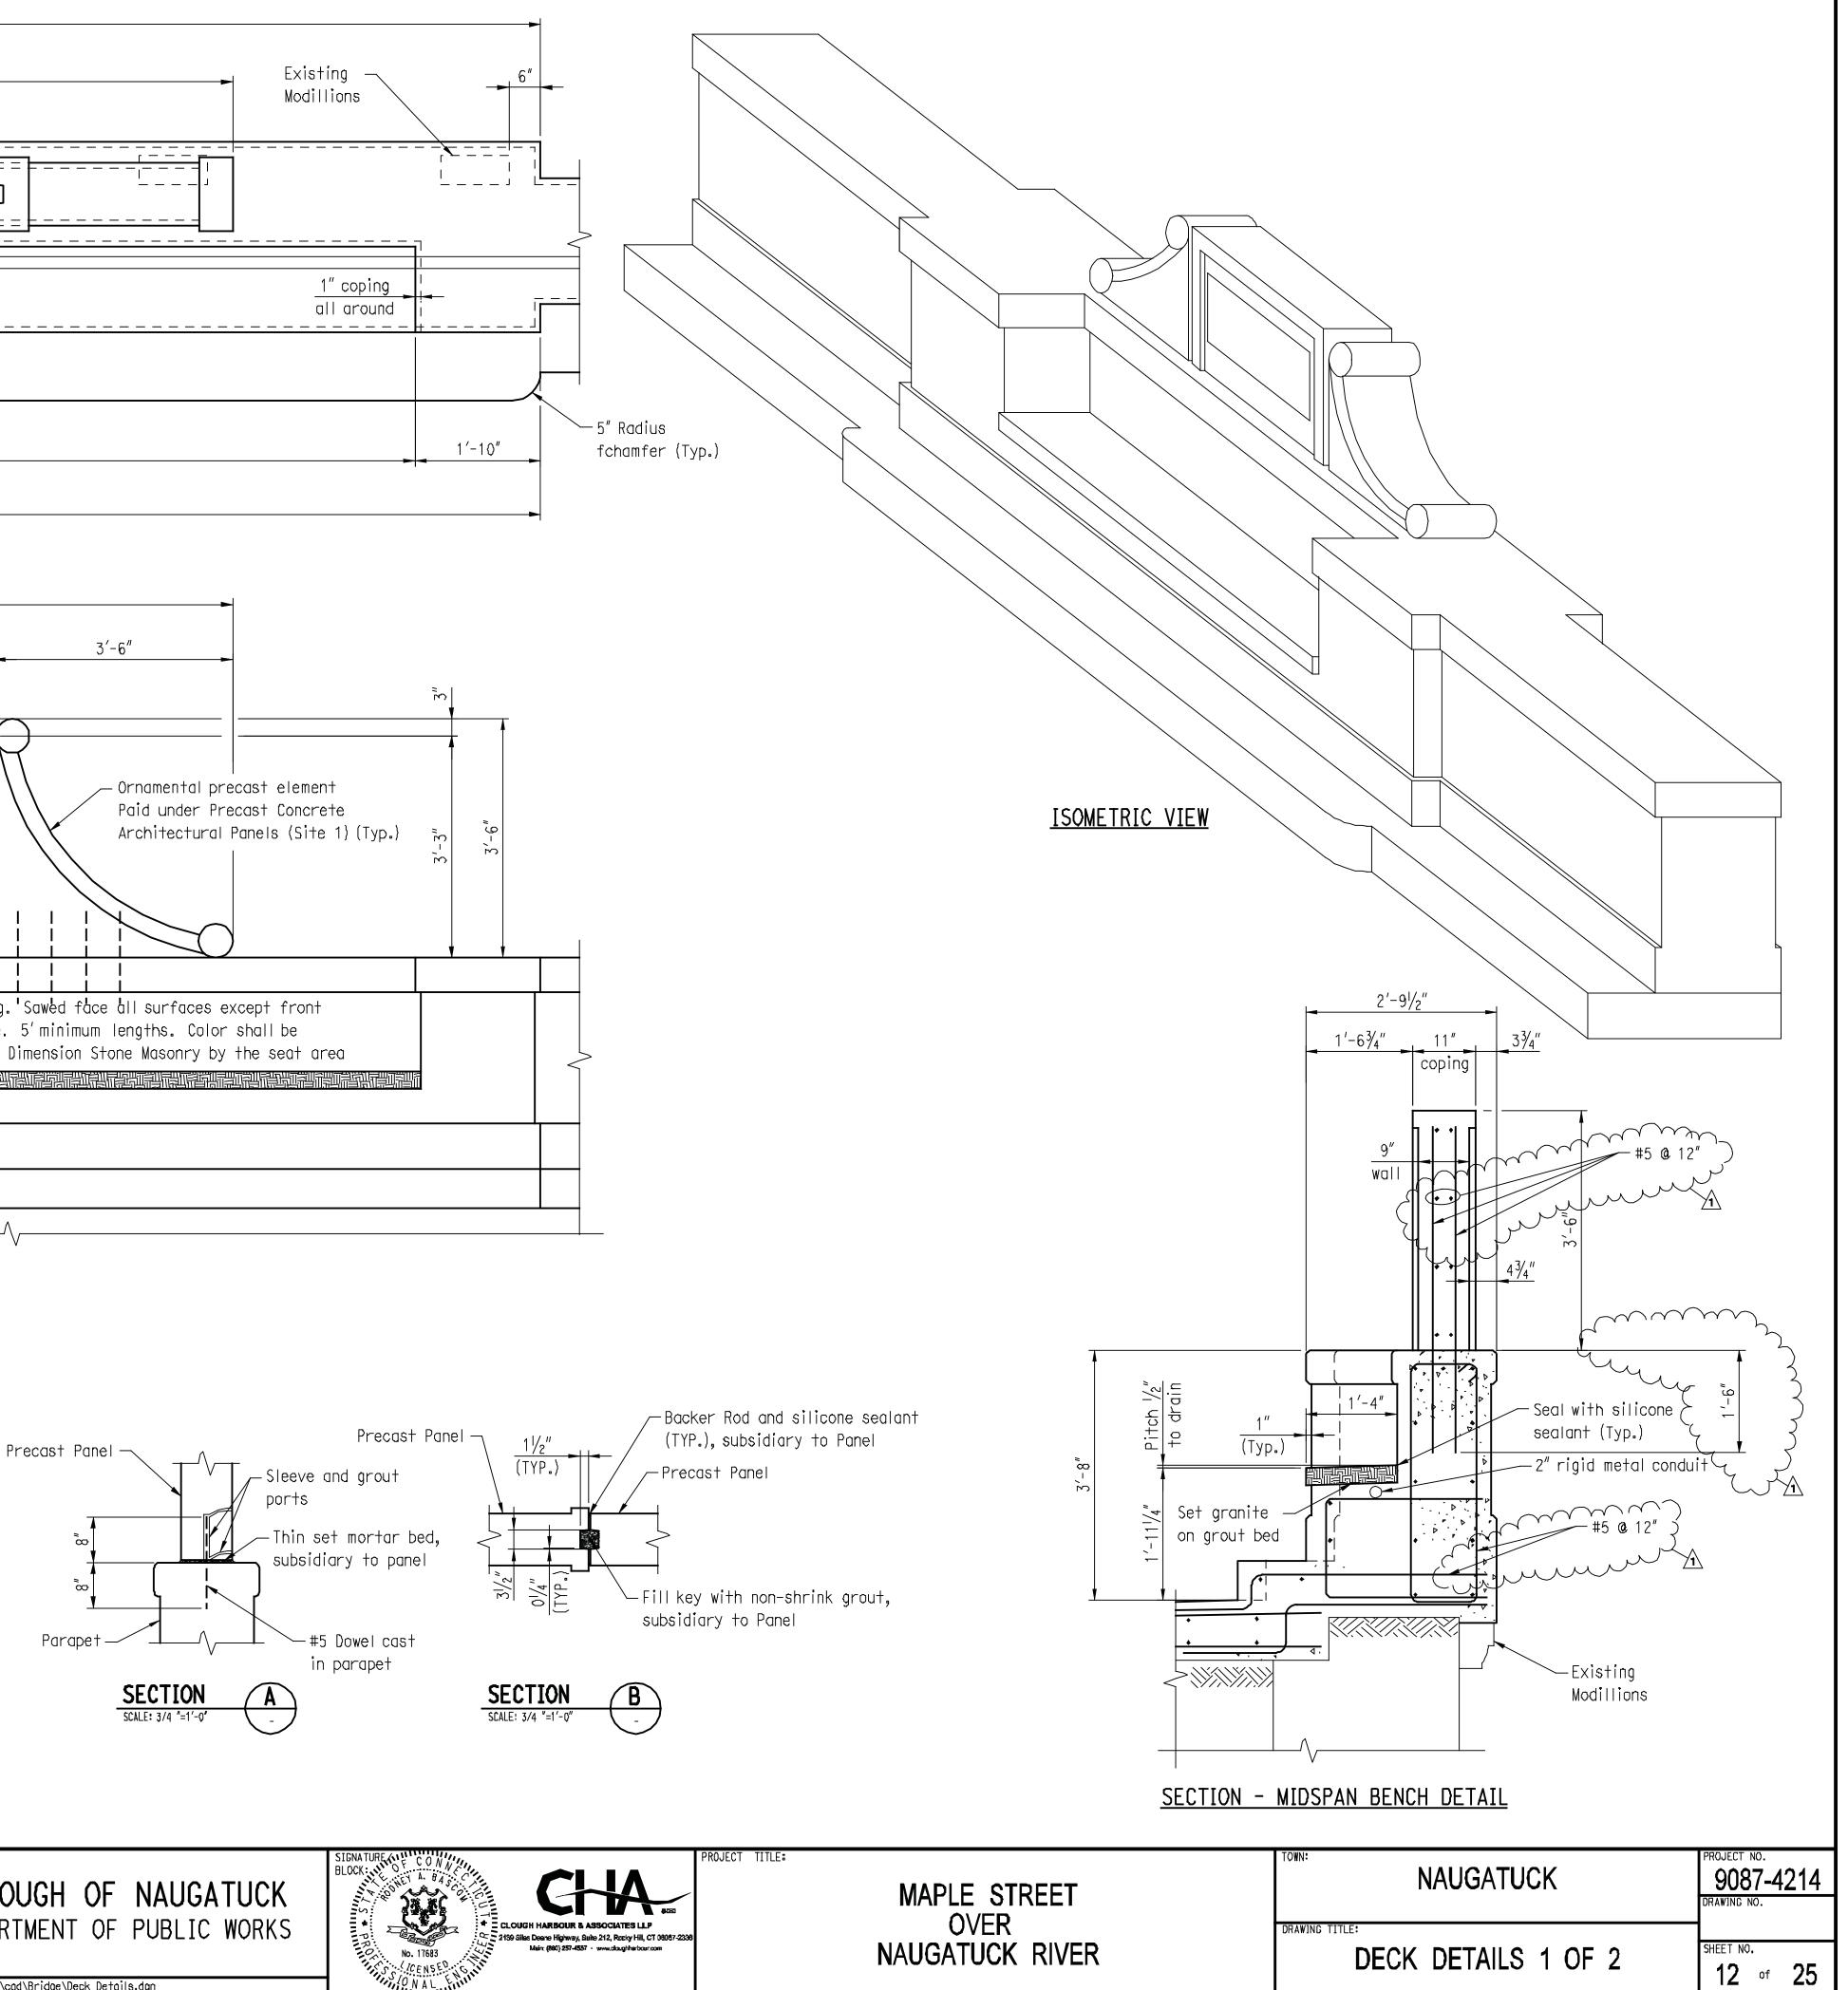
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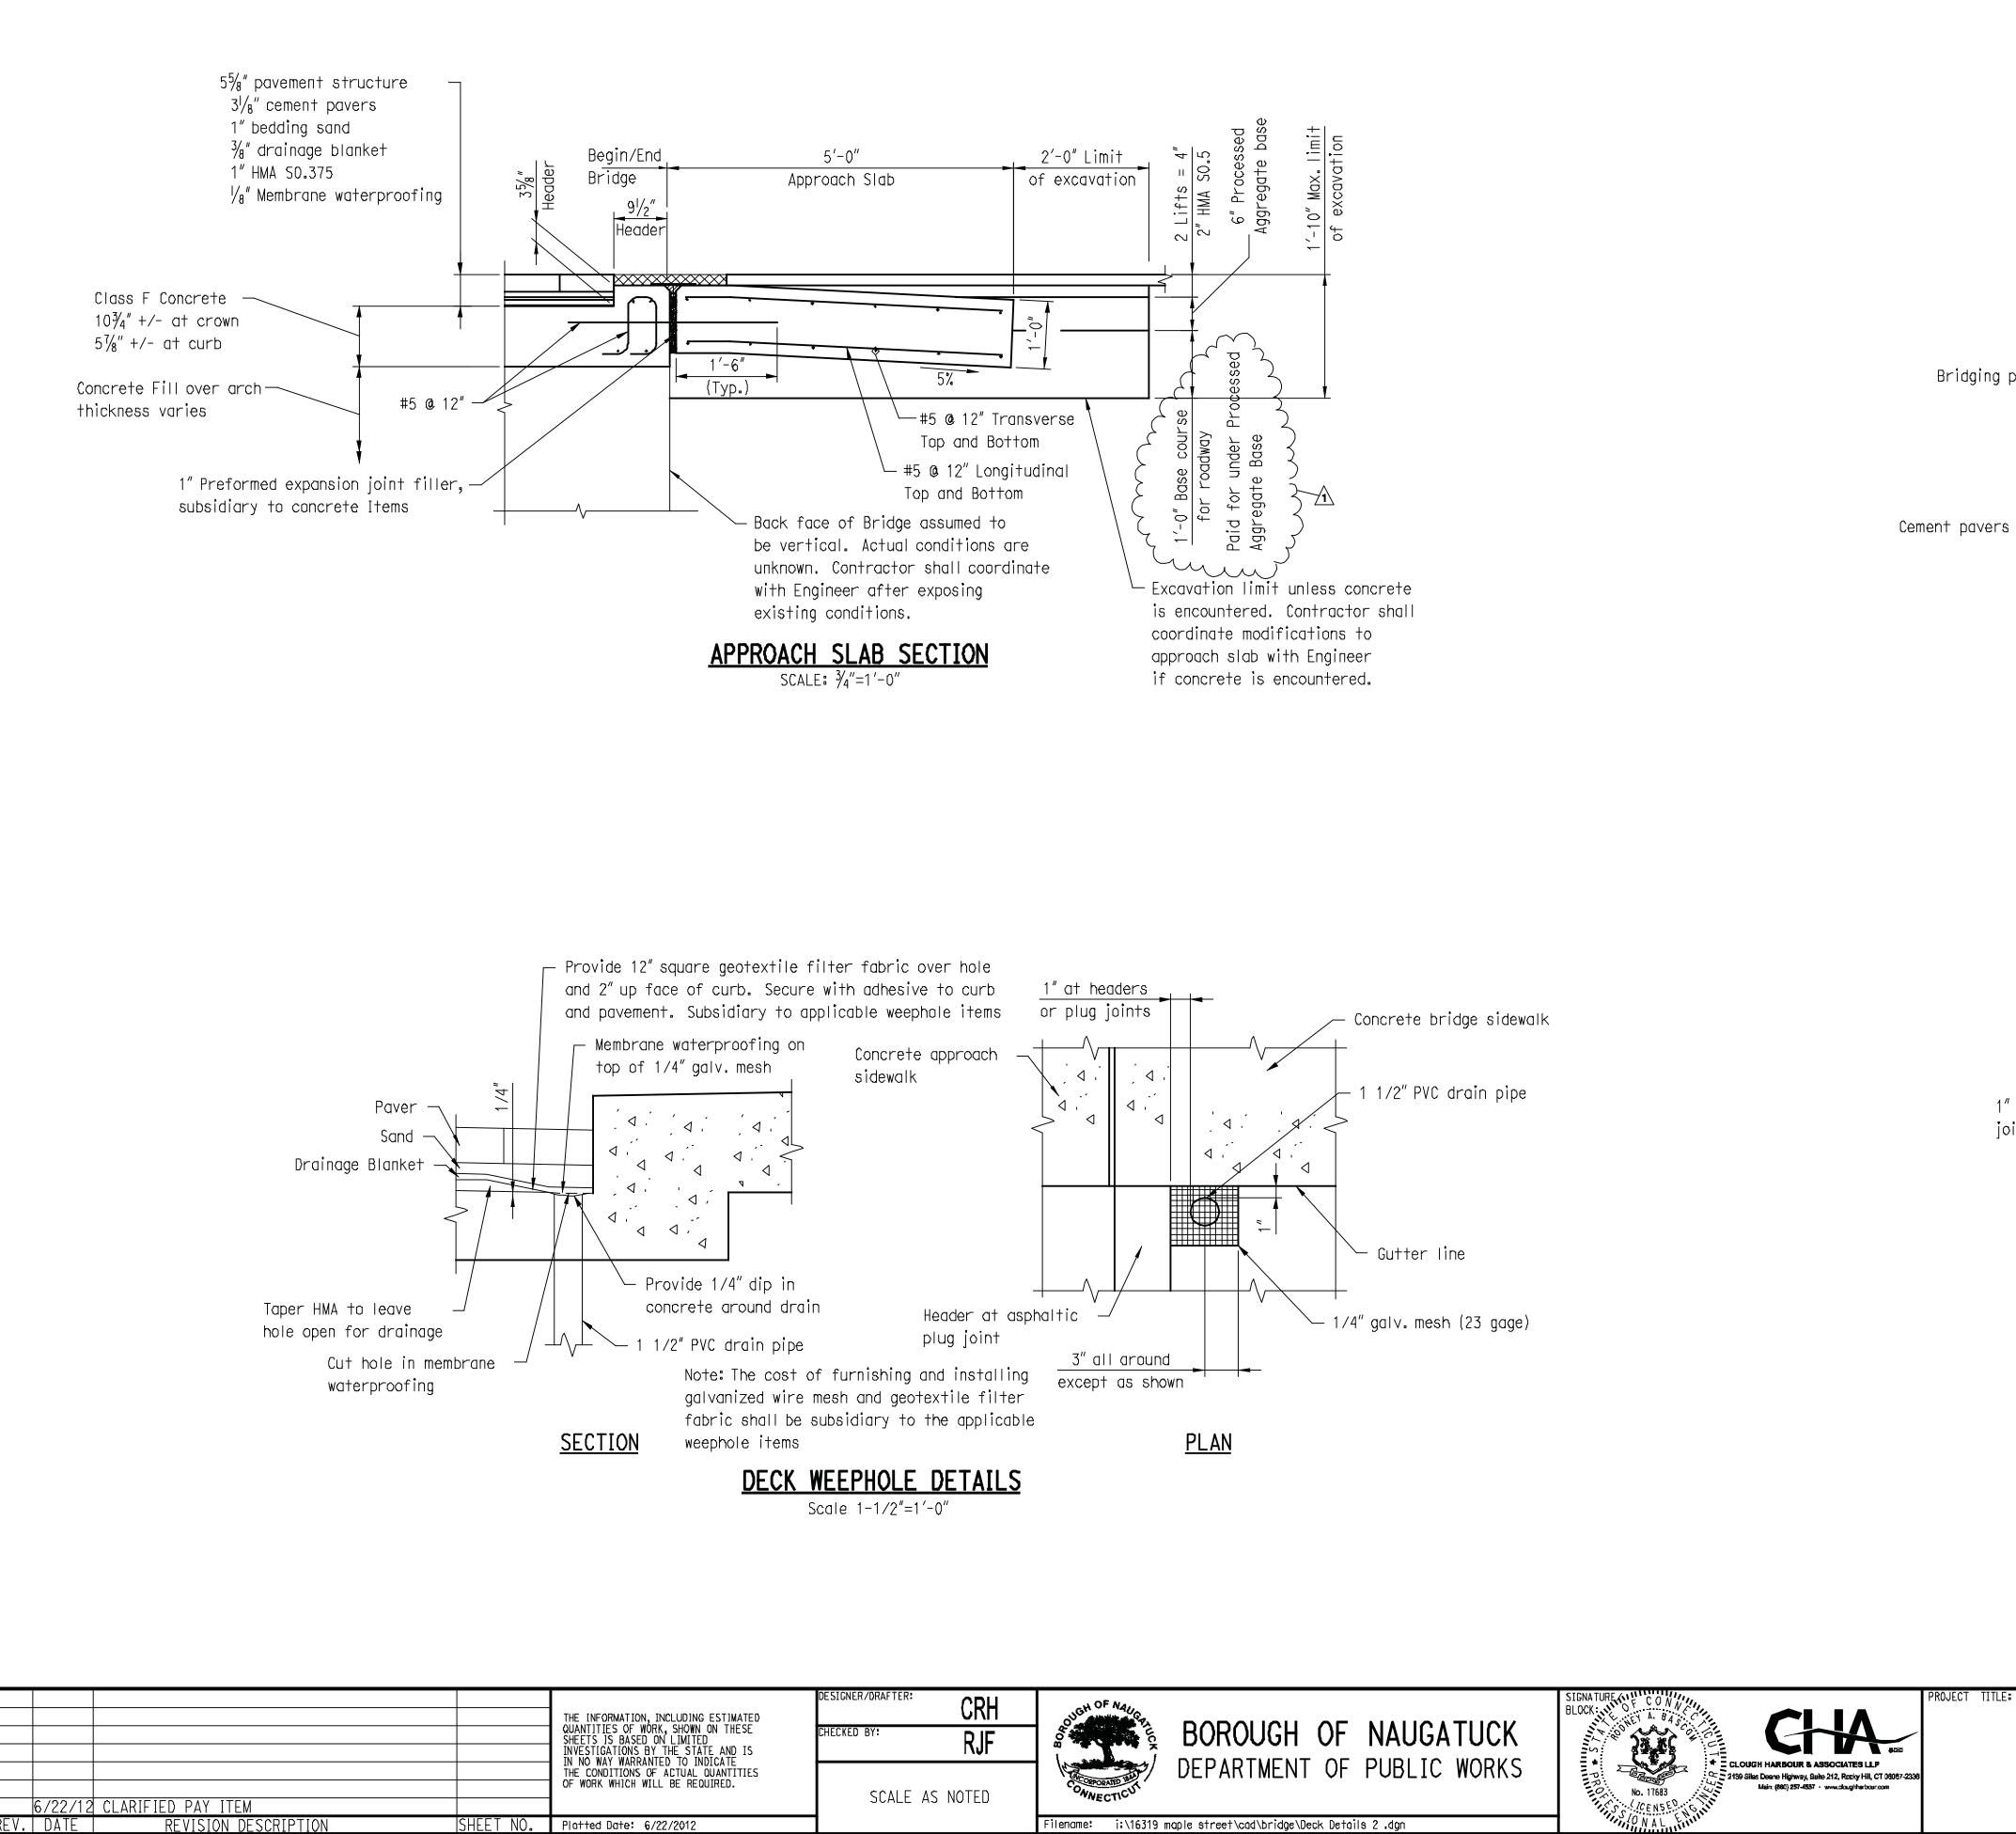
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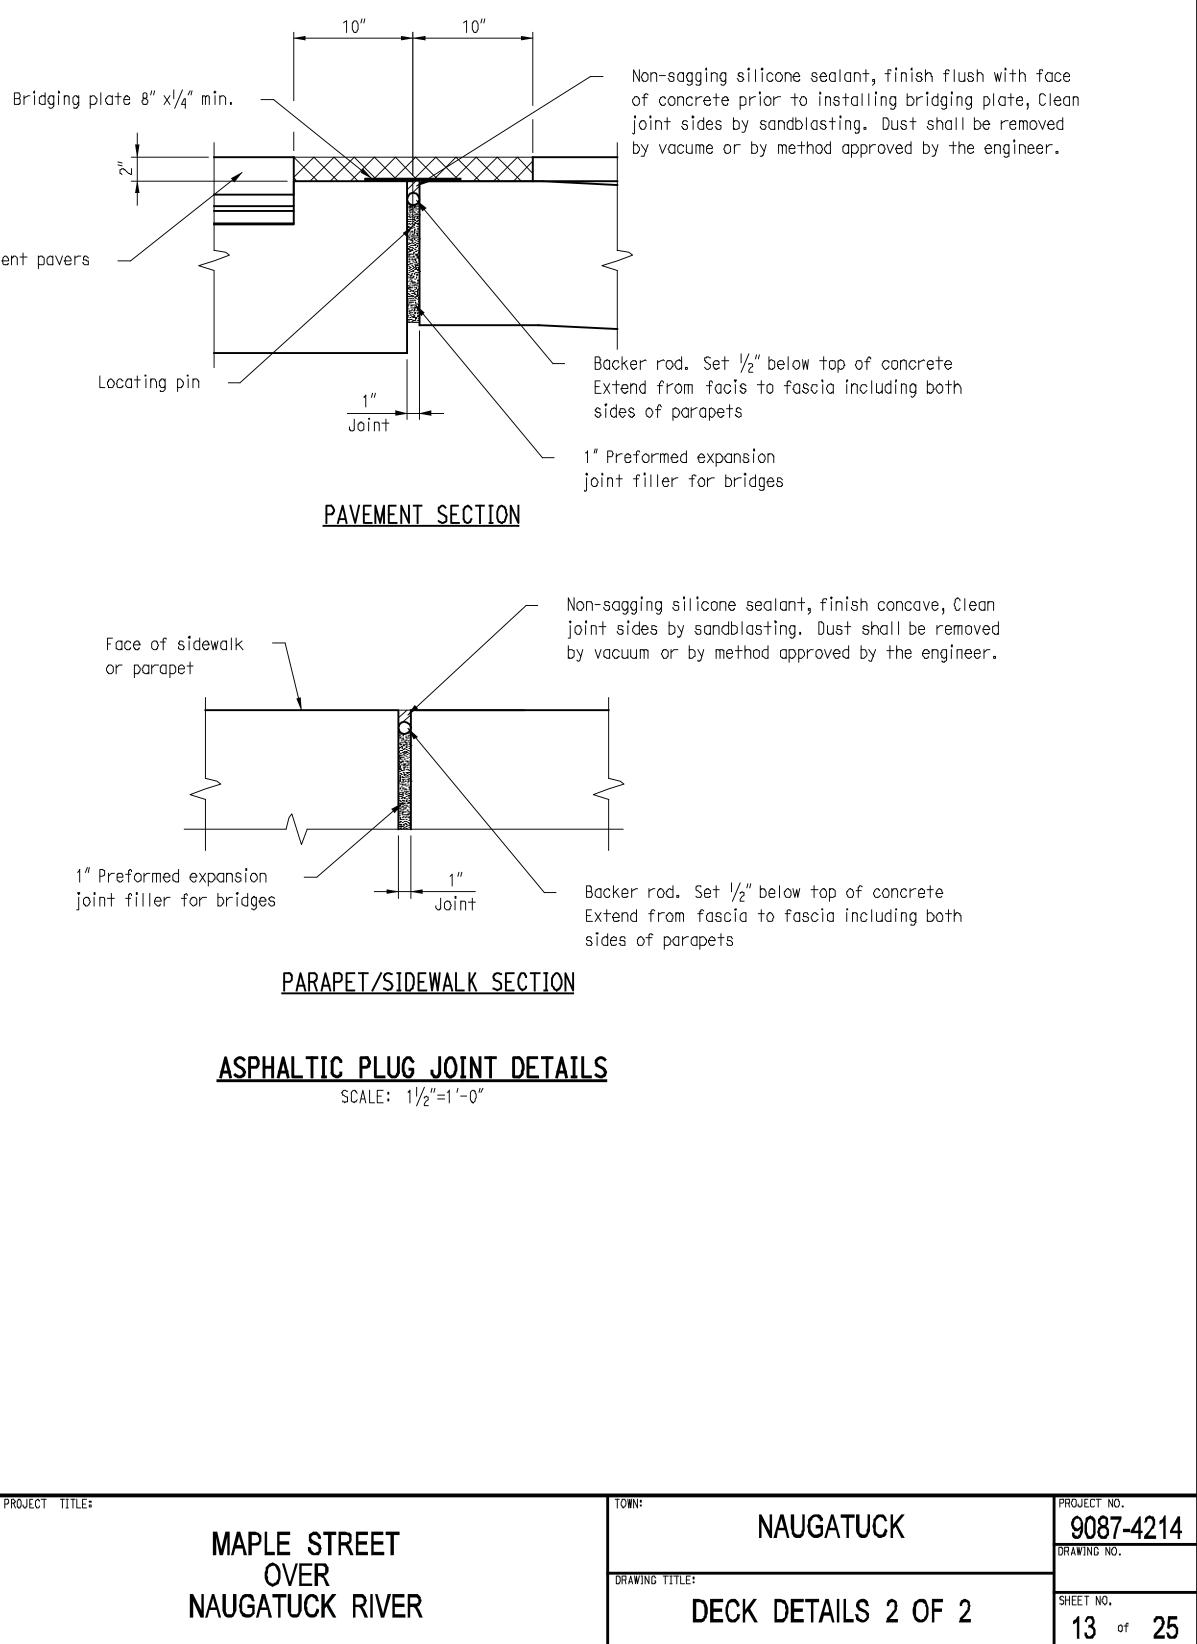
t (Typ.) - 2) Rigid I Conduit i By Contro	n Structure	
	TES:	
	DETAIL AT CURB AND PARAPET MAY BE ADJUSTED DURING CONSTRUCT CONTRACTOR SHALL REMOVE EXISTING CONCRETE AND PAVEMENT TO E GRANITE ARCH. ENGINEER WILL INSPECT ACTUAL SITE CONDITIONS A PROPOSED DETAILS IF NECESSARY.	XPOSED
granite arch	SEE STAGE 1 AND STAGE 2 CROSS SECTIONS, SHEETS 21-22 FOR CO STRUCTURE CONSTRUCTION DETAILS. SEE UTILITY PLAN, SHEET 6, A DETAILS, SHEET 7, FOR ADDITIONAL UTILITY RELOCATION DETAILS.	
10"	THE CEMENT PAVERS ON THE BRIDGE INCLUDING THE PAVERS, BEDDIN AND DRAINAGE BLANKET SHALL BE PAID UNDER THE "BRICK PAVING"	
	ALL CONCRETE FOR PATCHING THE STRUCTURAL CONCRETE ARCH SHAL THE "VARIABLE DEPTH PATCH" ITEM. ALL OTHER CONCRETE INCLUDIN SIDEWALK, AND PARAPETS SHALL BE PAID UNDER THE "CLASS F CONC	G FILL, BRIDGE
	TWO FEET OF VERTICAL SEPARATION SHALL BE PROVIDED BETWEEN T MAIN (YANKEE GAS) AND THE 2" RIGID METAL CONDUIT.	HE 6″I.P.GAS
	ADDITIONAL COVER MAY BE OBTAINED FOR CONDUITS AT SUPPORTS, M OF 2'OF VERTICAL COVER OVER 2" RIGID METAL CONDUIT.	AINTAIN MINIMUM
+6	CONCRETE PARAPETS SHALL BE RUBBED TO A SMOOTH FINISH WITHIN PLACING THE CONCRETE.	4 DAYS OF
	anchorage by Contractor	
8"×8'	Deck Details 2, Sheet 12) x8" cast iron ion box (Typ.)	
ranite arch		
10" anite Arch		
		PROJECT NO.
IAPLE STREET OVER	NAUGATUCK	9087-4214 DRAWING NO.
UGATUCK RIVER	DECK SECTION AND DETAILS	SHEET NO. 11 of 25









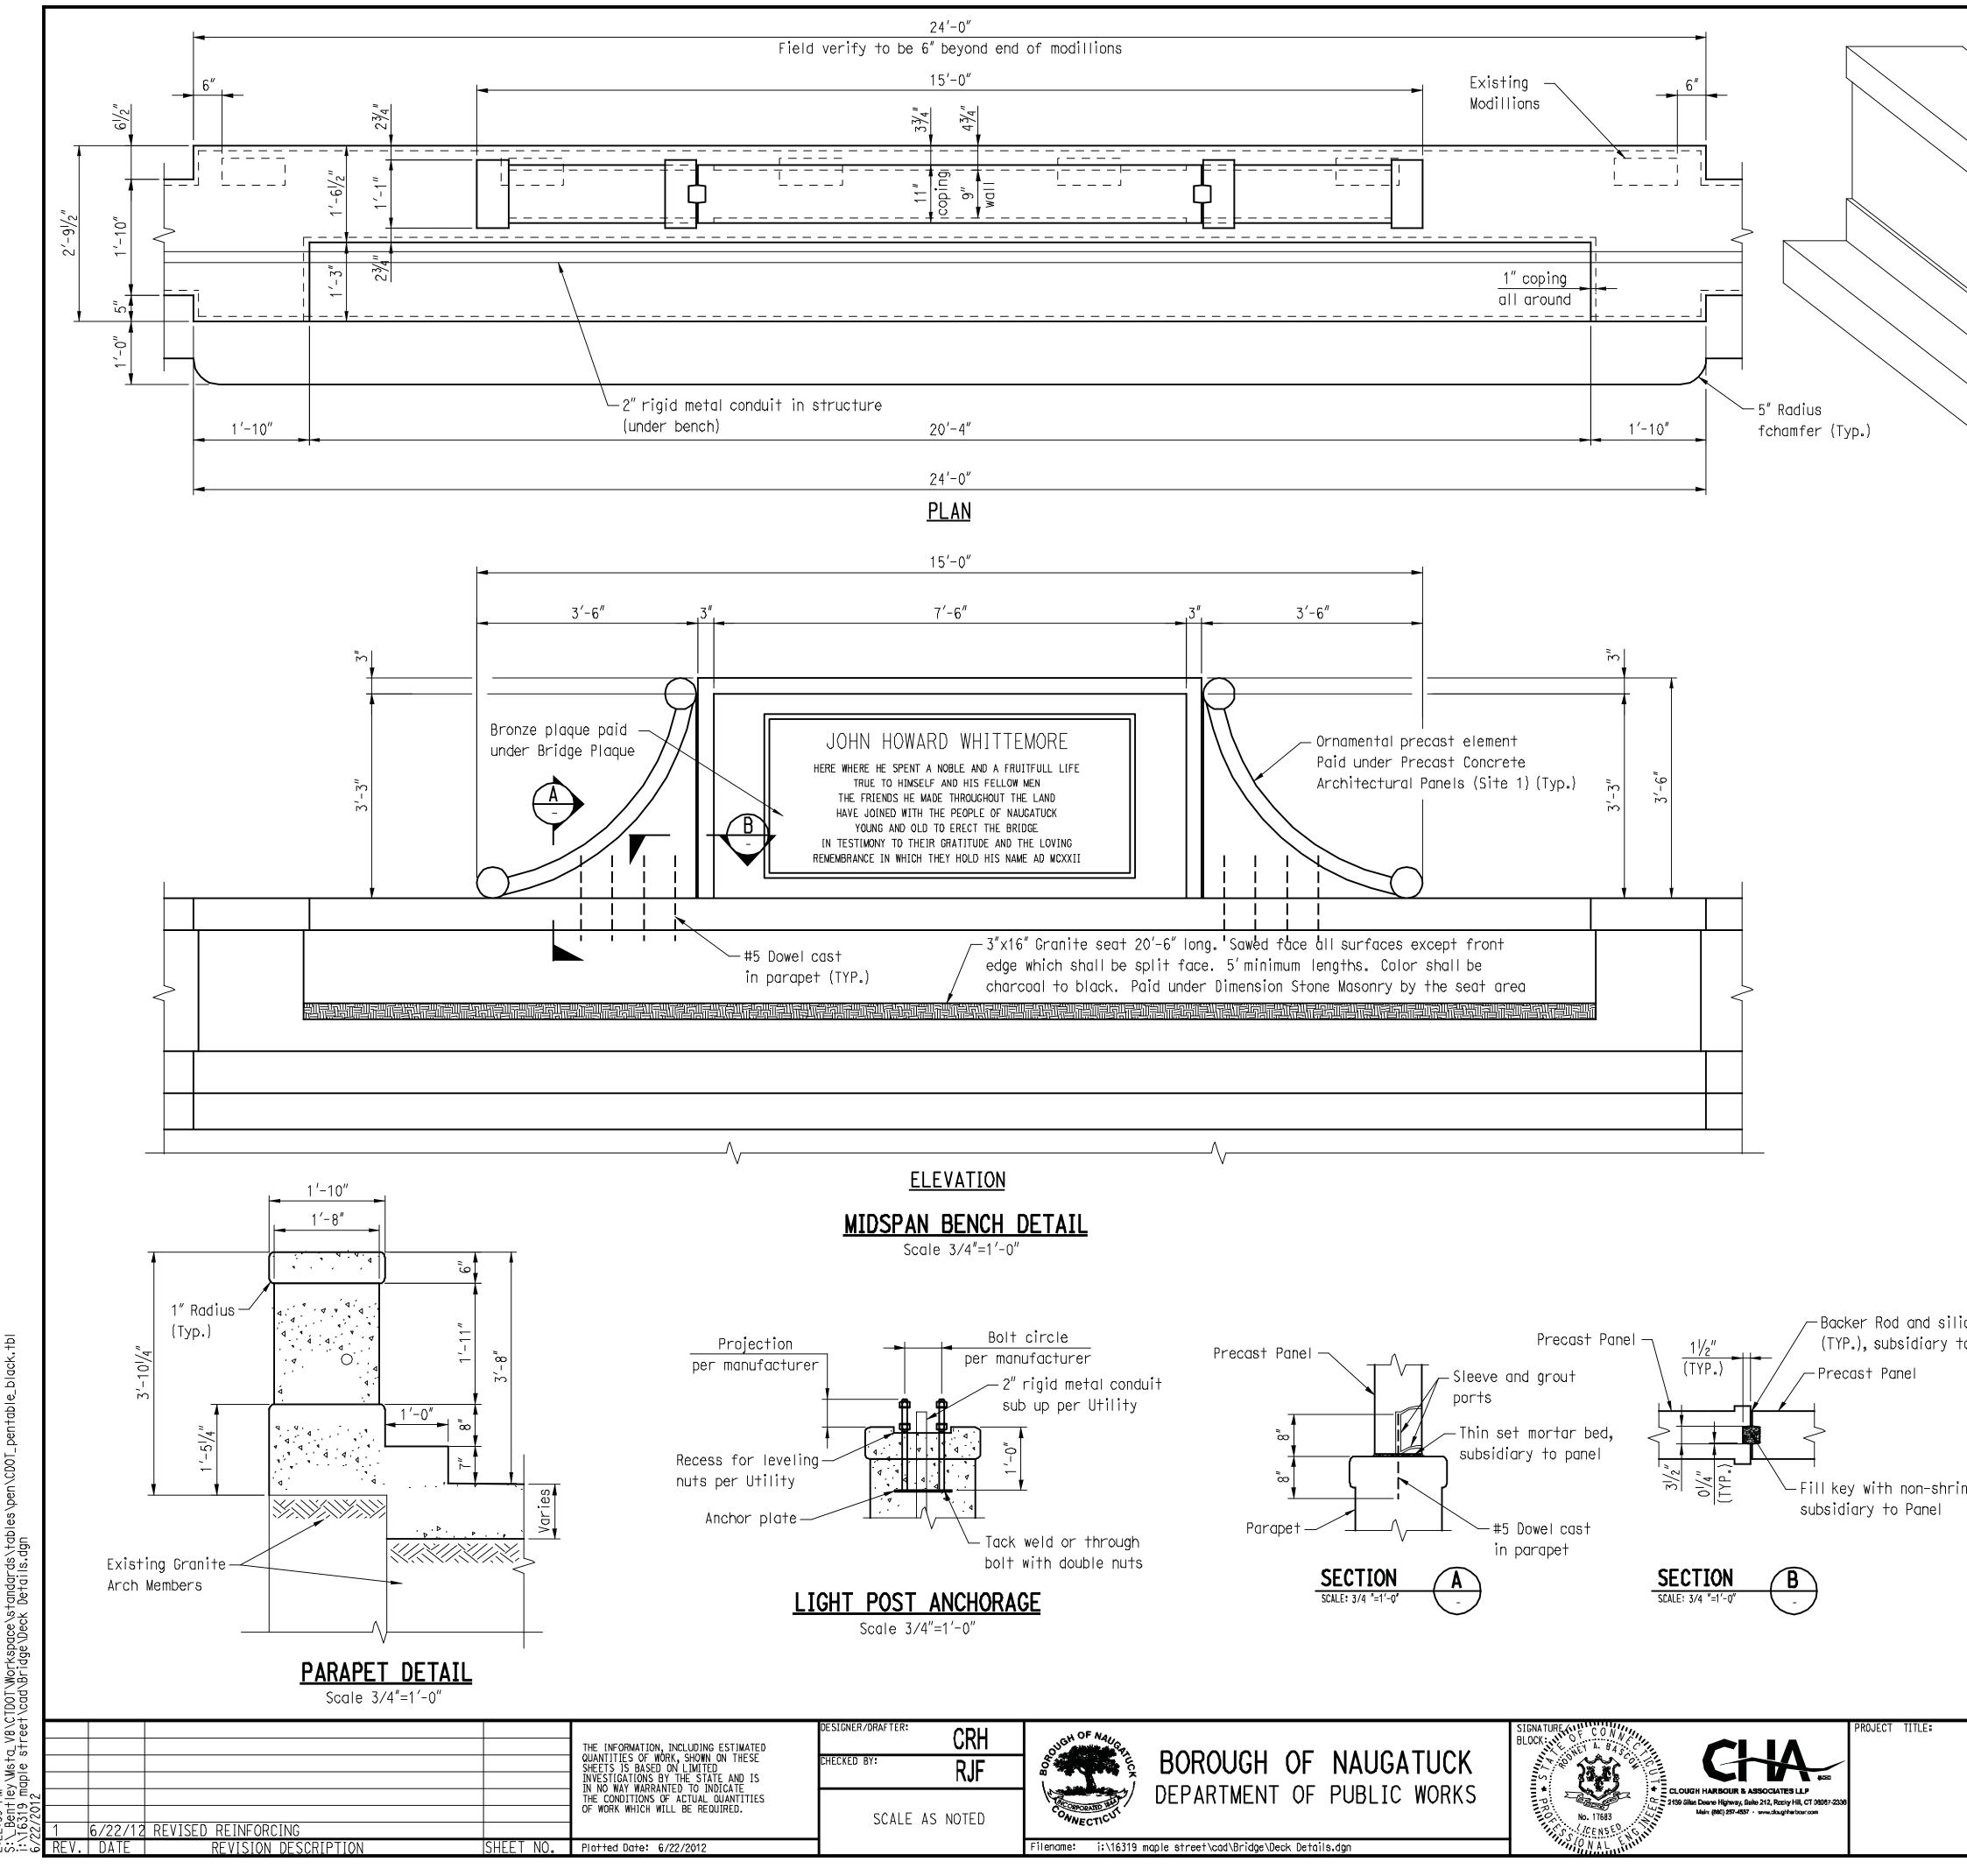




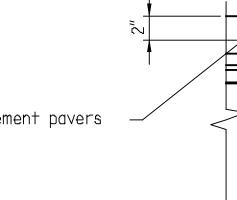

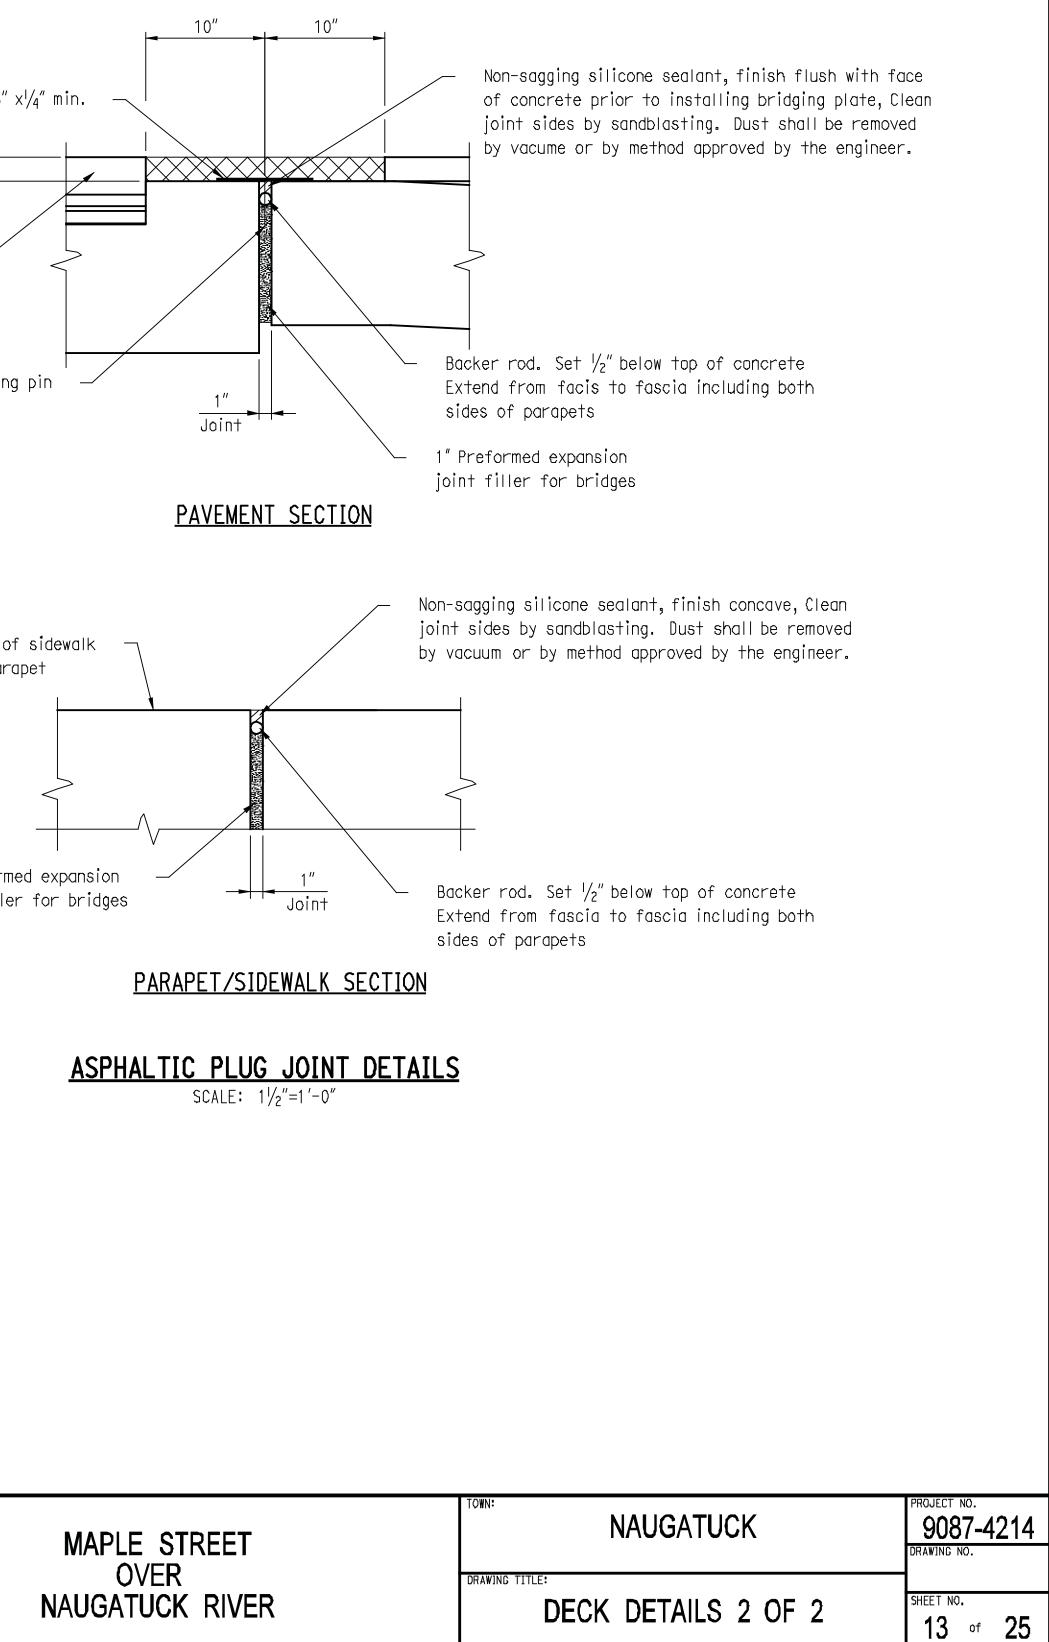

ASPHALTIC PLUG JOINT NOTES:

- 1. Cement pavers shall be placed prior to placing approach pavement. Approach pavement shall be placed up to cement pavers.
- 2. After approach pavement is placed, saw cut pavement 2" deep, 20" from edge of pavers. Remove pavement between saw cut and pavers. Install the asphaltic plug expansion joint system.
- 3. All costs for cutting and removing pavement, installing backer rod, silicone sealant, bridging plate, centering pin and asphaltic plug shall be included in the Asphaltic Plug Expansion Joint System.

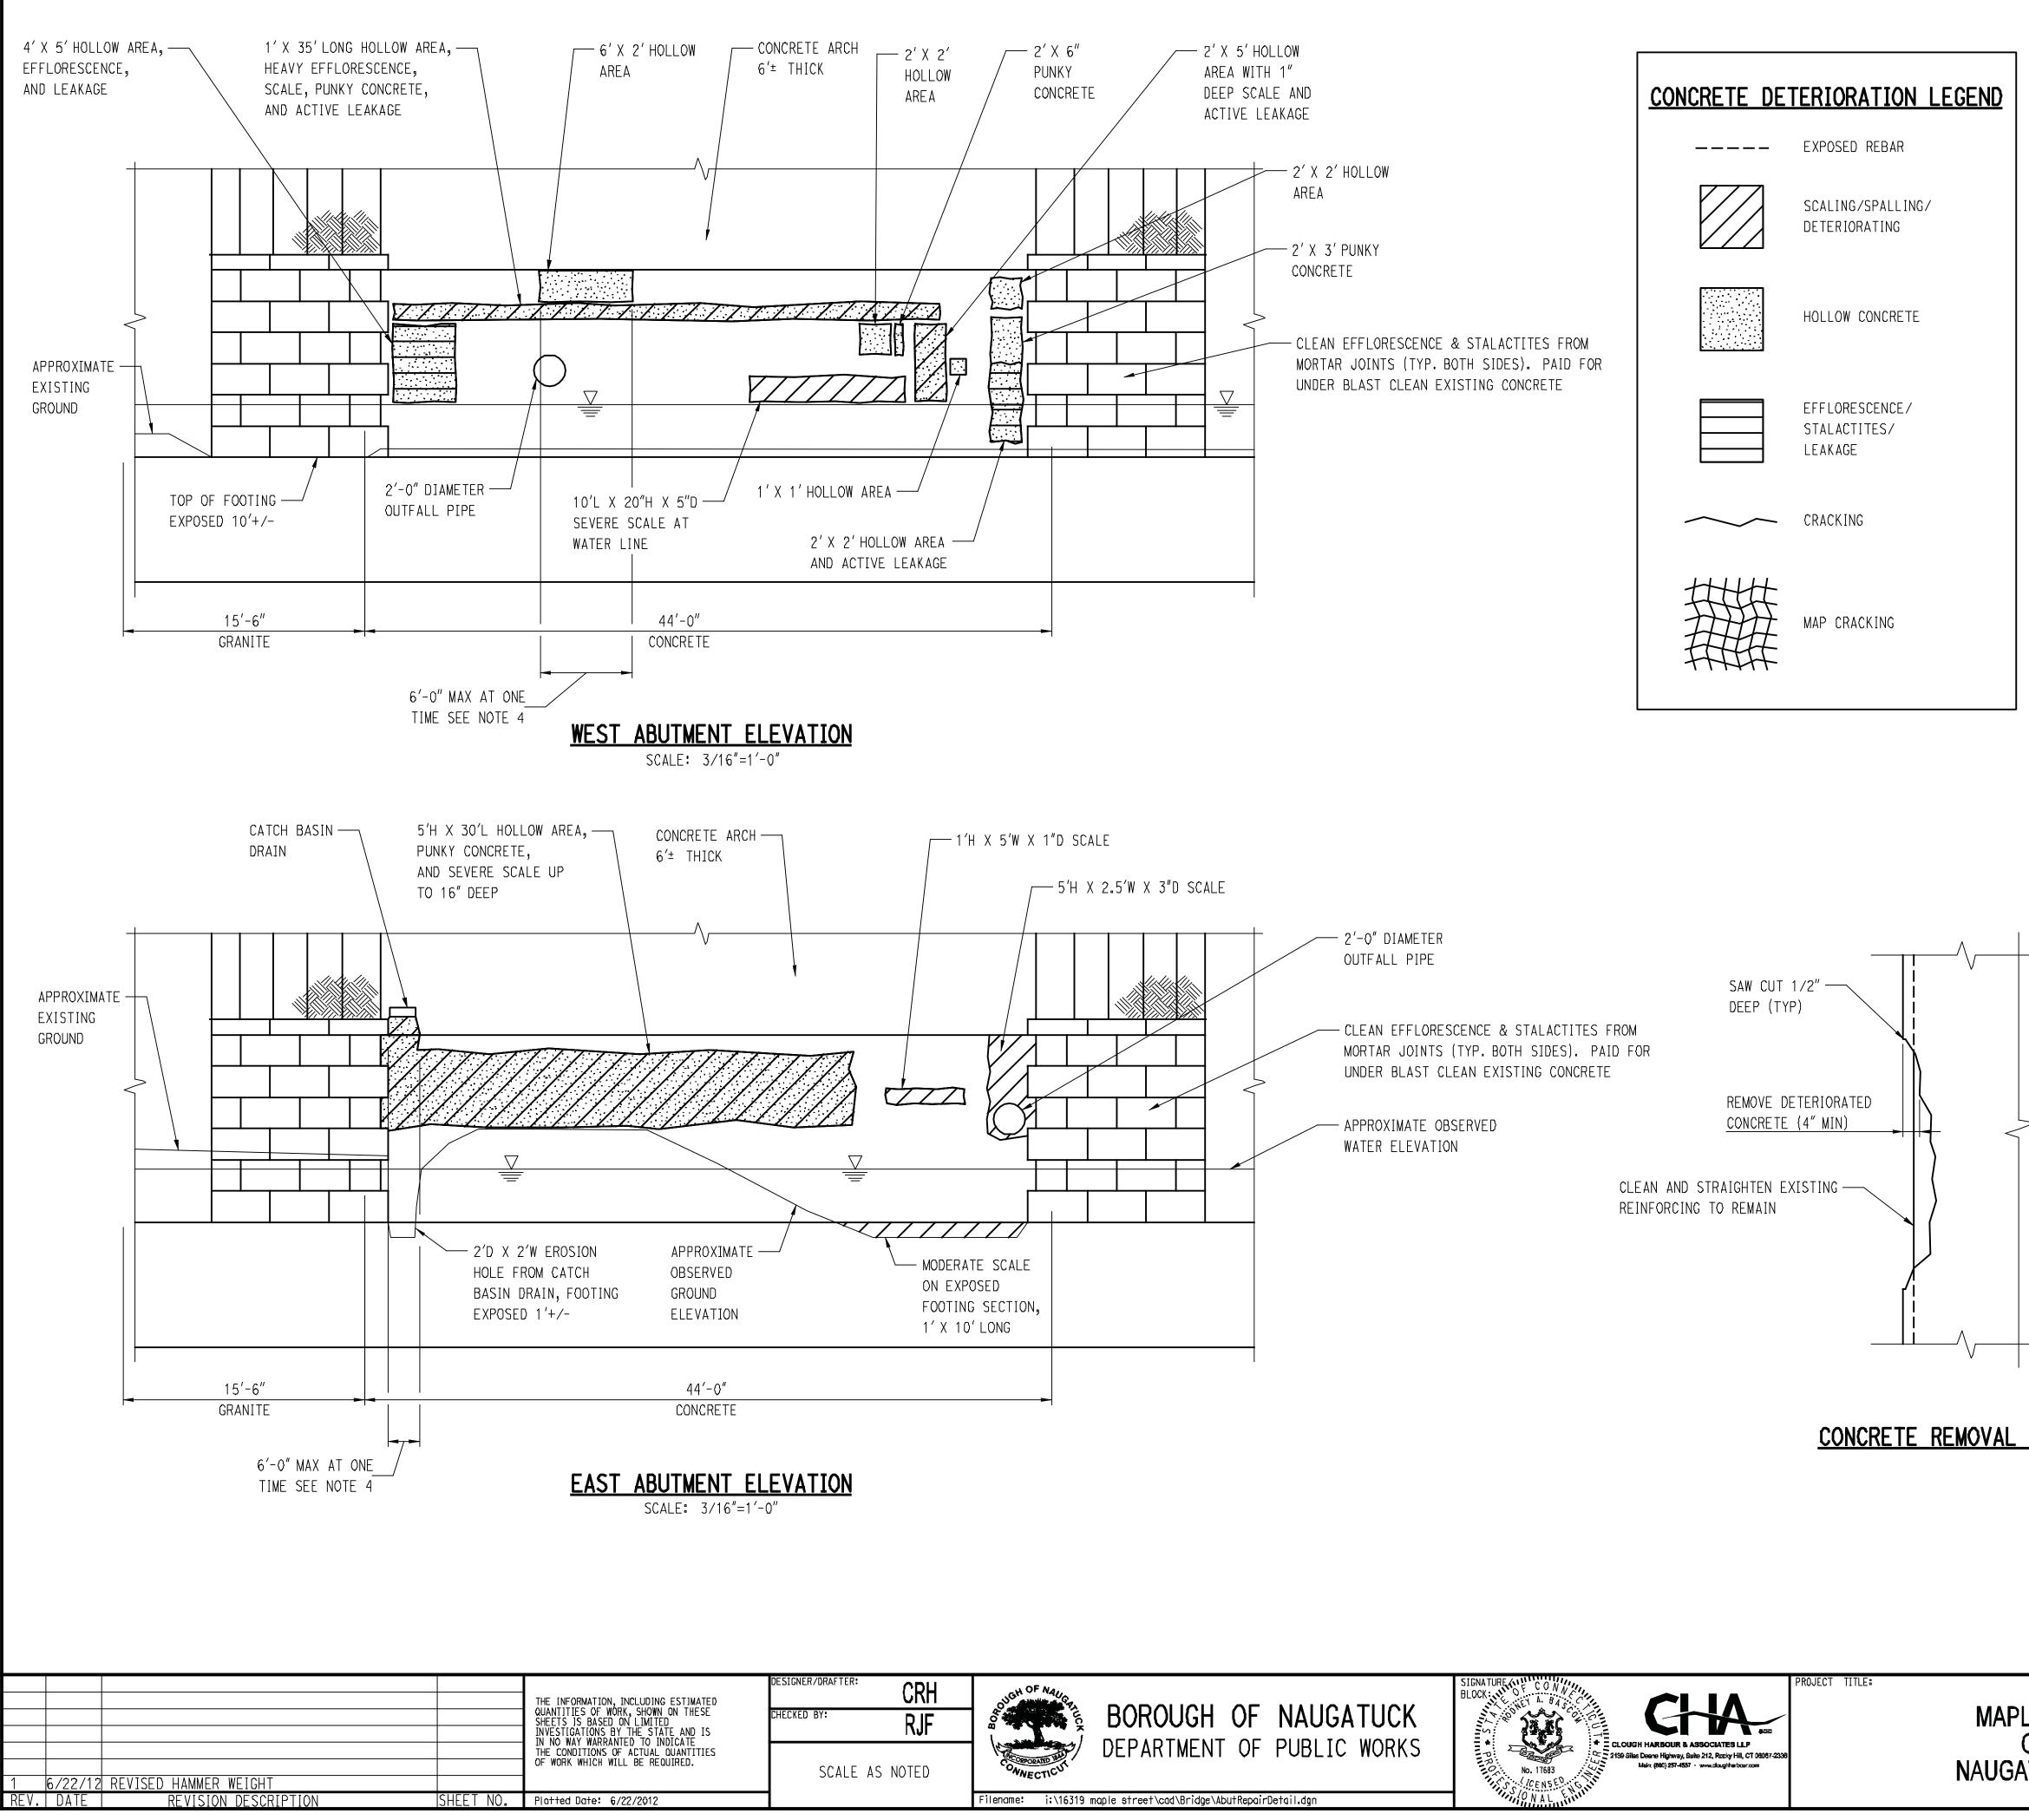


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CONCRETE REPAIR NOTES:

- 1. PRIOR TO ANY DEMOLITION, THE EXISTING STRUCTURE SHALL BE INSPECTED FOR DETERIORATED CONCRETE JOINTLY BY THE ENGINEER AND CONTRACTOR AND MARKED. THE CONCRETE SHALL BE SAW CUT 1/2" DEEP WHERE MARKED AND ALL DETERIORATED CONCRETE SHALL BE REMOVED. THE CONCRETE SURFACES SHALL BE PRESSURE WASHED PRIOR TO PLACING THE NEW CONCRETE. COST OF INSPECTION, SAW CUTTING, REMOVAL, CLEANING, AND PLACING CONCRETE SHALL BE INCLUDED IN VARIABLE DEPTH PATCH.
- 2. CARE SHALL BE TAKEN TO NOT DAMAGE ANY EXISTING REINFORCING. EXISTING REINFORCING SHALL BE CLEANED AND STRAIGHTENED TO FIT BACK IN THE NEW STRUCTURE. CLEANING OR STRAIGHTENING REINFORCING IS INCLUDED IN VARIABLE DEPTH PATCH. REINFORCING THAT IS DETERIORATED SHALL BE REPLACED OR SPLICED TO NEW REINFORCING AS DIRECTED BY THE ENGINEER. NEW REINFORCING WILL BE PAID FOR UNDER DEFORMED STEEL BARS. REINFORCING THAT IS DAMAGED BY THE CONTRACTOR SHALL BE REPAIRED OR REPLACED WITHOUT COMPENSATION.
- ~ 30 <u>}</u>1 3. CONCRETE SHALL BE REMOVED BY SMALL CHIPPING HAMMERS WEIGHING LESS THAN 20 LBS WITH THE BIT REMOVED. ONLY CHISEL POINT BITS SHALL BE USED. BITS SHALL BE RE-SHARPENED AS DIRECTED BY THE ENGINEER. SHARPENING BITS IS INCLUDED IN VARIABLE DEPTH PATCH. BITS SHALL BE ORIENTED AT AN ANGLE LESS THAN 60 DEGREES TO THE CONCRETE SURFACE DURING CHIPPING SO AS TO NOT CAUSE IMPACT FRACTURES TO THE CONCRETE TO REMAIN.
- 4. THE AMOUNT OF CONCRETE THAT CAN BE REMOVED PRIOR TO REPLACING WITH NEW CONCRETE IS LIMITED. THE STRUCTURE SHALL BE REPAIRED IN 6'-0" (MAX) WIDE STRIPS. THE DETERIORATED CONCRETE WITHIN A STRIP SHALL BE REMOVED AND REPAIRED PRIOR TO PROCEEDING WITH AN ADJACENT STRIP. THE INTENT IS TO MAINTAIN THE INTEGRITY OF THE ARCH TO SUPPORT DEAD LOAD ONLY WHILE REPAIRING DETERIORATED CONCRETE. CONTRACTOR BID PRICE SHALL ACCOUNT FOR REPAIRING THE BRIDGE IN MULTIPLE STRIPS IN EACH STAGE.
- 5. CONTRACTOR SHALL USE TARPS OR OTHER DEBRIS SHIELD UNDER AREAS OF DEMOLITION TO COLLECT DEBRIS. CONTRACTOR SHALL PICK UP ANY DEBRIS THAT FALLS ON THE GROUND AT THE END OF EACH DAY AND AS DIRECTED BY THE ENGINEER.
- 6. THE LIMITS OF DETERIORATION SHOWN ON THE PLANS WAS TAKEN FROM FIELD INSPECTION REPORTS. THESE REPORTS ARE AVAILABLE FOR REVIEW FROM THE CONNECTICUT DEPARTMENT OF TRANSPORTATION. PETROGRAPHIC TEST REPORTS ON THE DURABILITY AND SOUNDNESS OF THE CONCRETE ARE AVAILABLE FROM THE BOROUGH OF NAUGATUCK. THE ACTUAL LIMITS TO BE REPAIRED MAY BE SIGNIFICANTLY DIFFERENT FROM THOSE SHOWN. THE CONTRACTOR SHALL PROVIDE THE ENGINEER ACCESS TO ALL CONCRETE SURFACES. THE CONTRACTOR AND ENGINEER SHALL DETERMINE AND MARK THE ACTUAL LIMITS OF REMOVAL IN THE FIELD.

 MODIFIED CLASS F CONCRETE, - SUBSIDIARY TO VARIABLE DEPTH PATCH, SEE SPECIFICATION CLEAN SURFACE WITH PRESSURE WASHER JUST PRIOR TO PLACING CONCRETE, SUBSIDIARY TO VARIAE DEPTH PATCH REPLACE DETERIORATED REINFORG WITH #5 BARS AS DIRECTED. PA FOR UNDER DEFORMED STEEL BAR SPLICE NEW REINFORCING TO - EXISTING AS DIRECTED. PAID FOR UNDER DOWEL BAR SPLICER SYSTEM 	CING	R UNDER
<u>DETAIL</u>	TOWN:	PROJECT NO.
E STREET OVER	DRAWING TITLE:	9087-4214 DRAWING NO.
TUCK RIVER	ABUTMENT REPAIR DETAIL	SHEET NO. 14 of 25

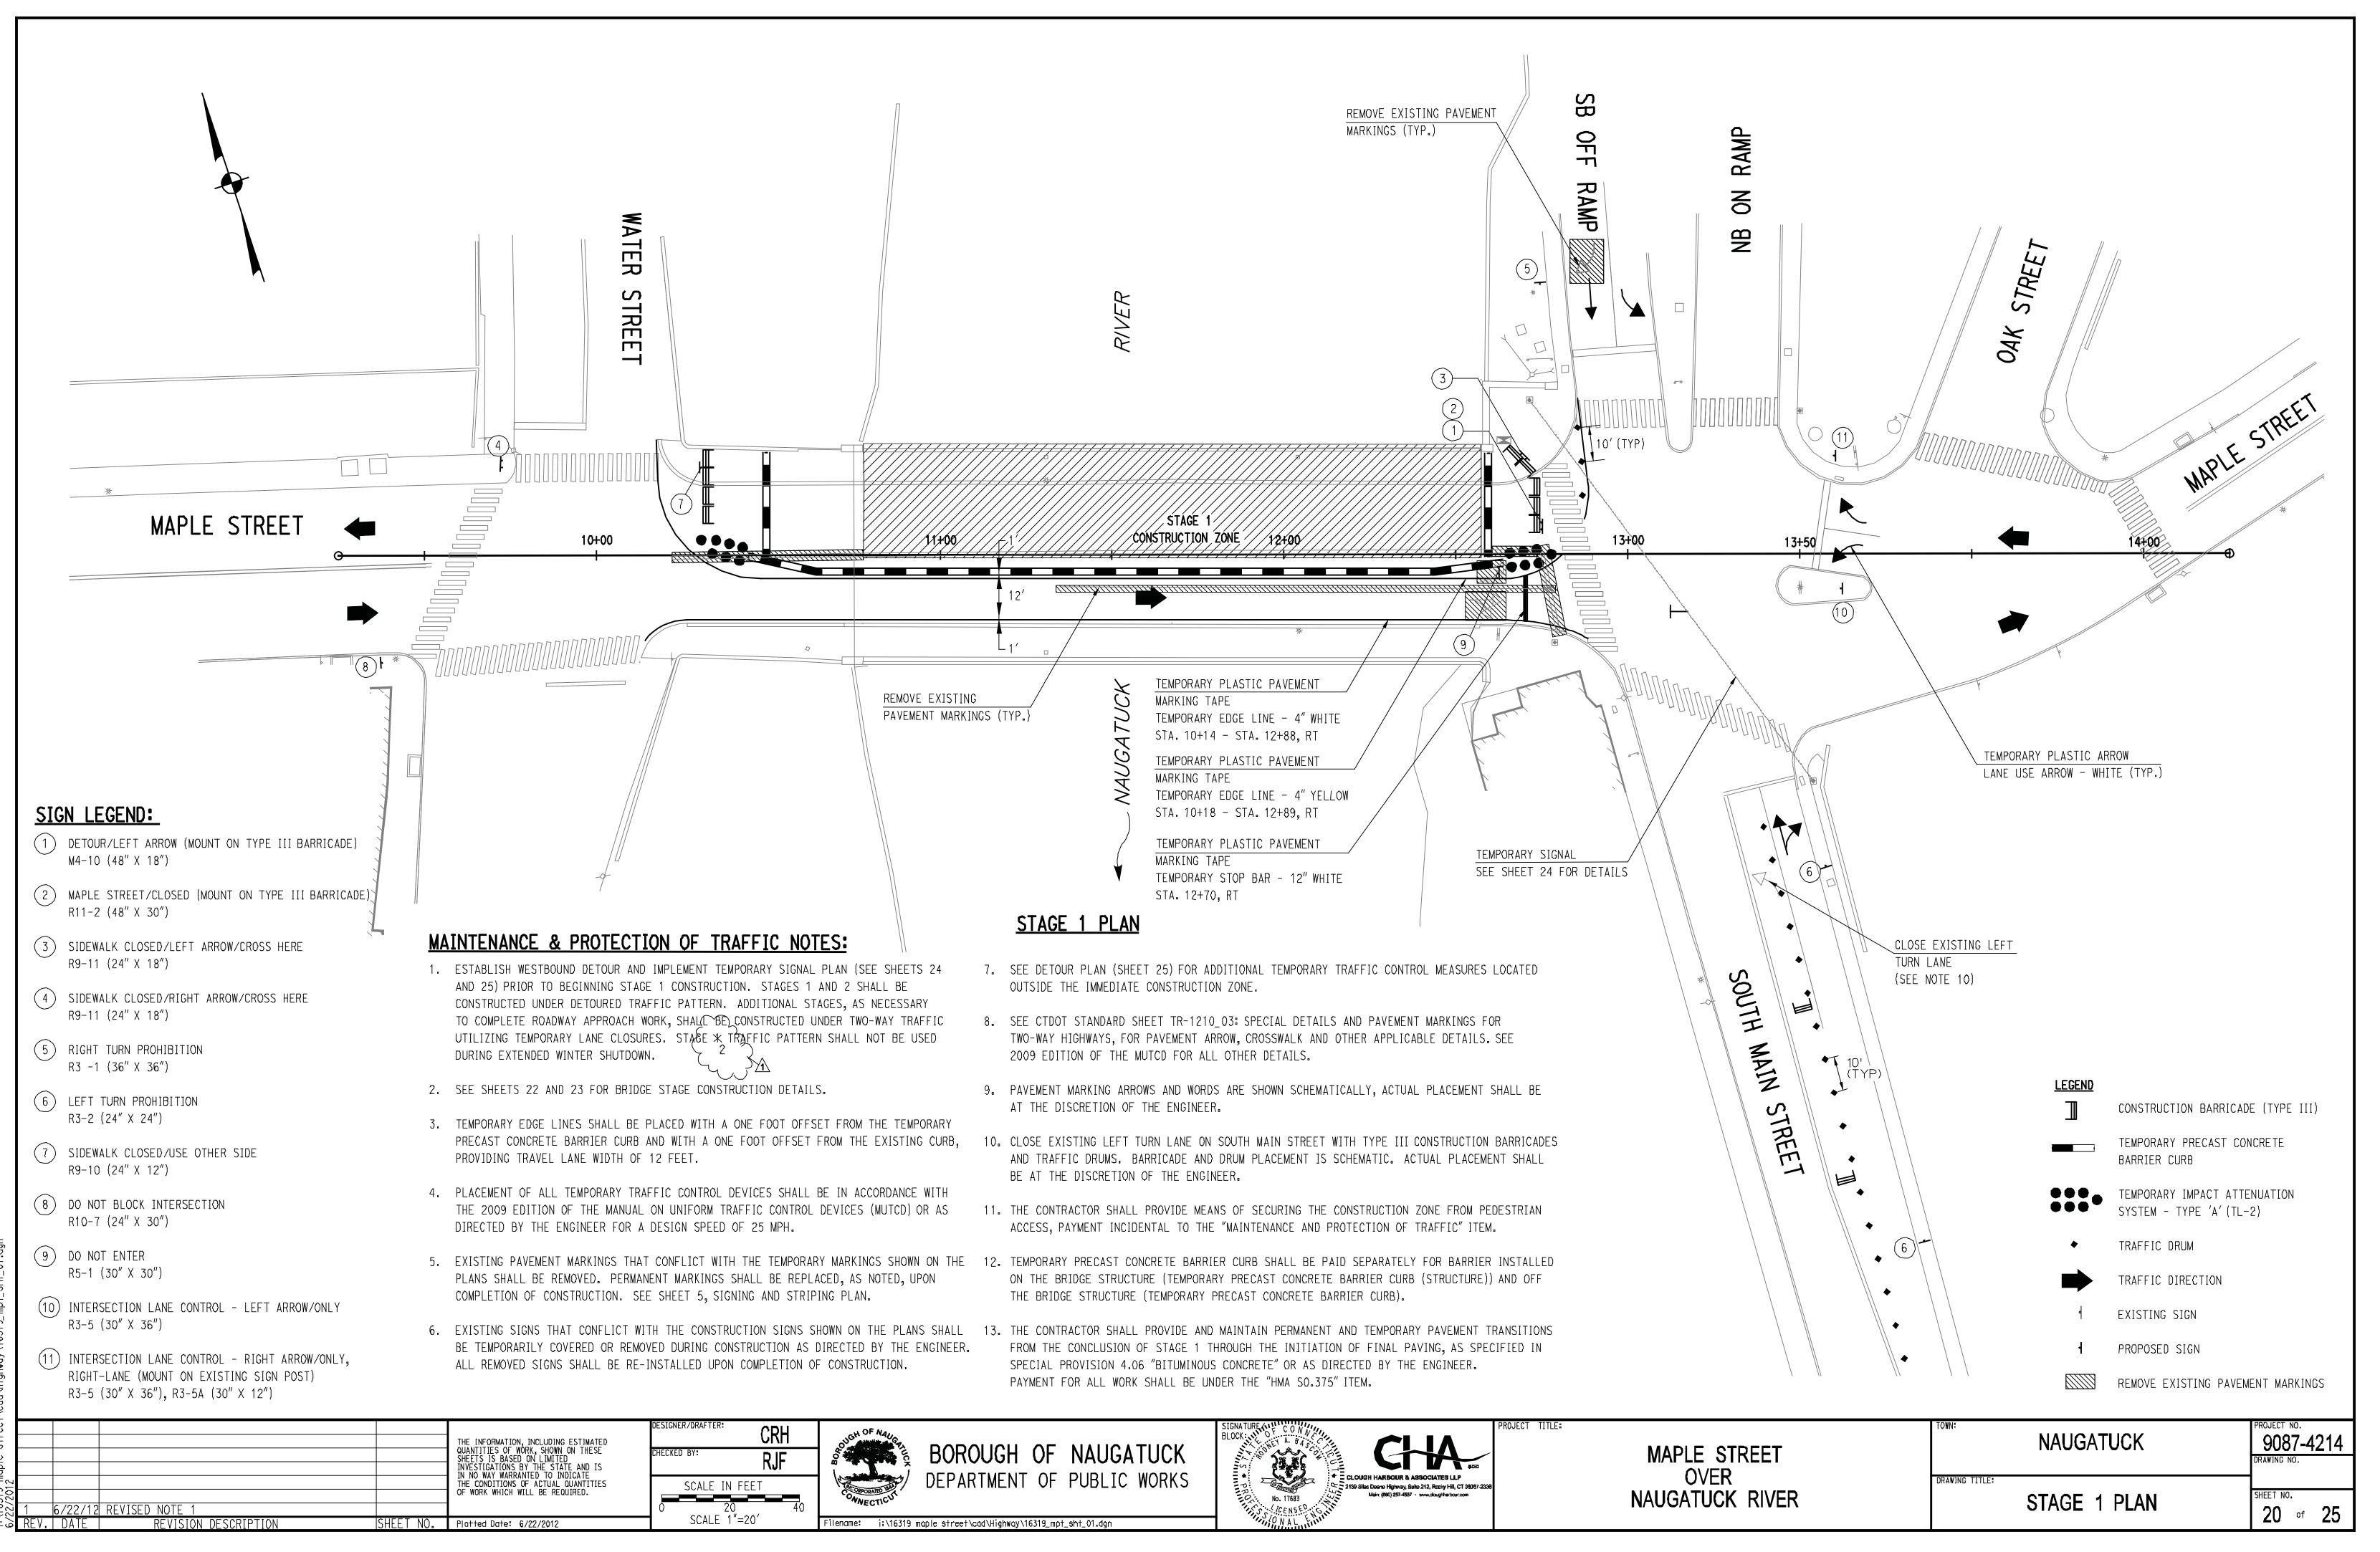

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