

BOROUGH OF NAUGATUCK DEPARTMENT OF PUBLIC WORKS




PLANS FOR REHABILITATION OF STRUCTURE MAPLE STREET OVER NAUGATUCK RIVER BRIDGE NO. 04214


STATE PROJECT 9087-4000


FROM STA. 9+40.0 TO STA. 12+83.0

LENGTH 343.0 FT

		LIST	OF DRAWINGS	
SHEET N	O. TITLE	SHEET NO.	CTDOT STANDARD SHEETS	APPROVAL DATE
1	TITLE SHEET	ALL	http://www.ct.gov/dot/cwp/view.asp?a=2303&q=410884	VARIOUS
2	GENERAL NOTES AND QUANTITIES			
3	GENERAL PLAN			
4	POCKET PARK PLAN & DETAILS			
5	TYPICAL SECTIONS			
6	SIGNING AND STRIPING PLAN			
7	UTILITY PLAN			
8	UTILITY DETAILS			
9	BRIDGE GENERAL PLAN			
10	BORING 1 OF 2			
11	BORING 2 OF 2			
12	DECK SECTIONS			
13	DECK DETAILS 1 OF 2			
14	DECK DETAILS 2 OF 2			
15	ABUTMENT REPAIR DETAIL			
16	PIER 1 REPAIR DETAIL			
17	PIER 2 REPAIR DETAIL			
18	ARCH REPAIR DETAIL			
19	CHANNEL PLAN 1 OF 2			
20	CHANNEL PLAN 2 OF 2			
21	STAGE 1 PLAN			
22	STAGE 2 PLAN			
23	STAGE 1 CROSS SECTIONS			
24	STAGE 2 CROSS SECTIONS			
25	TEMPORARY SIGNAL PLAN STAGE 1			
26	TEMPORARY SIGNAL PLAN STAGE 2			
27	DETOUR PLAN			

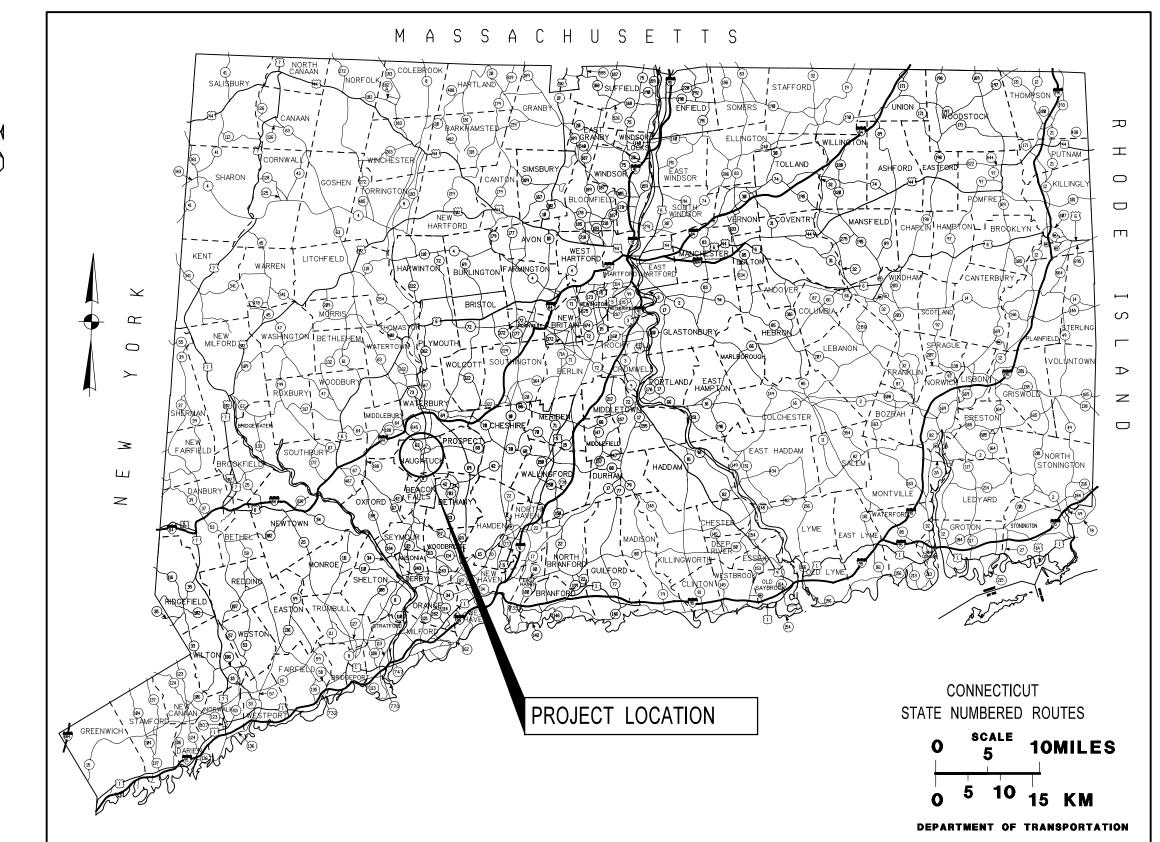

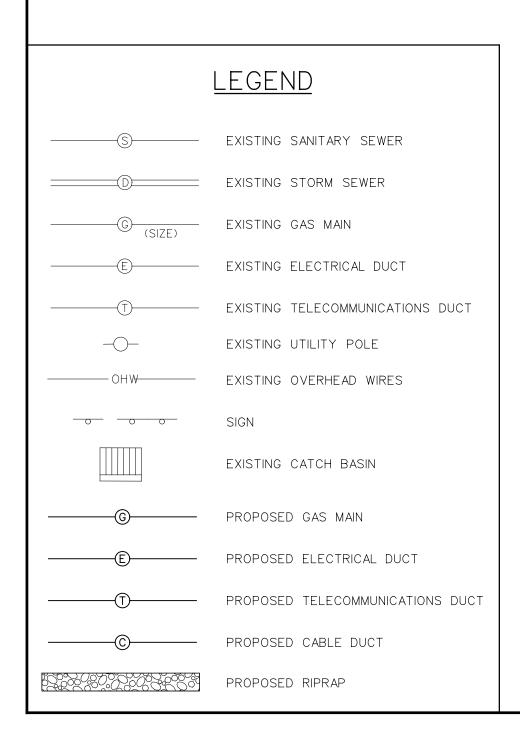

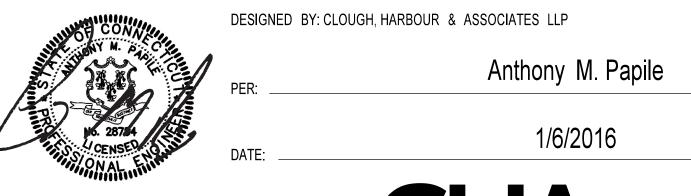



ITEM #	ITEM DESCRIPTION	UNIT	QUAI	NT.
1003906A	REMOVE LIGHT STANDARD	EA.	2	* *
1008138A	4" POLYVINYL CHLORIDE CONDUIT IN STRUCTURE	L.F.	380	
1008143A	4" POLYVINYL CHLORIDE CONDUIT UNDER ROADWAY	L.F.	950	
1008144A	5" POLYVINYL CHLORIDE CONDUIT UNDER ROADWAY	L.F.	1110	
1008215A	2" RIGID METAL CONDUIT UNDER ROADWAY	L.F.	200	
1008315A	2" RIGID METAL CONDUIT IN STRUCTURE	L.F.	340	
1008870A	5" FIBERGLASS CONDUIT - HEAVY WALL	L.F.	1520	
1009005	8" X 8" X 8" CAST IRON JUNCTION BOX	EA.	4	
1010917A	INSTALL PRECAST CONCRETE MANHOLE	EA.	2	
1108724A	PHASE SELECTOR	EA.	1	
1112410A	DETECTOR (TYPE A)	EA.	1	
1112470A	PRE-EMPTION SYSTEM CHASSIS	EA.	1	
1113550A	DETECTOR CABLE (OPTICAL)	L.F.	500	
1116100A	INTERNALLY ILLUMINATED SIGN (LED)	EA.	1	
1118051A	TEMPORARY SIGNALIZATION (SITE 1)	L.S.	1	
1206013A	REMOVAL OF EXISTING SIGNING	L.S.	1	
1208928	SIGN FACE - SHEET ALUMINUM (TYPE III REFLECTIVE SHEETING)	S.F.	80	
1208997A	ORNAMENTAL SIGN POST	EA.	4	* *
1209005	PAINTED PAVEMENT MARKINGS (4") (WHITE)	L.F.	600	
1209007	PAINTED PAVEMENT MARKINGS (4") (YELLOW)	L.F.	600	
1209009	PAINTED PAVEMENT MARKINGS (12") (WHITE)	L.F.	25	
1209401	PAINTED LEGEND, ARROWS AND MARKINGS	S.F.	150	
1210101	4" WHITE EPOXY RESIN PAVEMENT MARKINGS	L.F.	100	
1210102	4" YELLOW EPOXY RESIN PAVEMENT MARKINGS	L.F.	570	
1210104	8" WHITE EPOXY RESIN PAVEMENT MARKINGS	L.F.	110	
1210105	EPOXY RESIN PAVEMENT MARKINGS, SYMBOLS AND LEGENDS	S.F.	1200	
1210106	12" WHITE EPOXY RESIN PAVEMENT MARKINGS	L.F.	70	
1211001	REMOVAL OF PAVEMENT MARKINGS	S.F.	170	
1211003	REMOVAL OF PLASTIC PAVEMENT MARKINGS	S.F.	400	* *
1212001	TEMPORARY PLASTIC PAVEMENT MARKING TAPE (4") (YELLOW)	L.F.	600	* *
1212002	TEMPORARY PLASTIC PAVEMENT MARKING TAPE (4") (WHITE)	L.F.	600	* *
1212010	TEMPORARY PLASTIC PAVEMENT MARKING TAPE (12") (WHITE)	L.F.	25	* *
1212017	TEMPORARY PLASTIC LEGEND ARROWS AND MARKINGS	S.F.	150	* *
1220027	CONSTRUCTION SIGNS	S.F.	500	
1504040A		L.S.	1	
1807016A	TEMPORARY IMPACT ATTENUATION SYSTEM TYPE A (TL-2)	EA.	2	
1807101	RELOCATION OF TEMPORARY IMPACT ATTENUATION SYSTEM TYPE A	EA.	2	

- * AN HOURLY RATE HAS BEEN INSERTED FOR BIDDING PURPOSES, HOWEVER THIS ITEM IS TO BE PAID BY THE ACTUAL COST UP TO THE NUMBER OF HOURS BID AS DESCRIBED IN THE SPECIFICATIONS.
- ** BOROUGH MAY CONSIDER ELIMINATING ANY ITEM FROM THE CONTRACT OR USING OTHER BID ITEMS FOR THE WORK AT THEIR DISCRETION. NO COMPENSATION WILL BE MADE TO THE CONTRACTOR FOR ELIMINATING ANY ITEMS. SPECIFICALLY THE ITEMS NOTED MAY BE ELIMINATED.

NOTE: THIS IS A REHABILITATION PROJECT AND QUANTITIES MAY VARY SIGNIFICANTLY FROM THOSE SHOWN ON THE PLANS. THE CONTRACTOR WILL BE PAID FOR THE ACTUAL QUANTITY OF ITEMS INSTALLED. NO ADJUSTMENT IN UNIT PRICES WILL BE MADE FOR QUANTITIES LESS THAN OR EXCEEDING THOSE SHOWN.

GENERAL NOTES:

- 1. DESIGN SPECIFICATIONS: ALL ROAD, DRAINAGE AND STRUCTURAL WORK (AND APPURTENANT WORK) SHALL BE PERFORMED IN ACCORDANCE WITH THE TECHNICAL REQUIREMENTS, INCLUDING MATERIALS AND METHODS, OF THE STATE OF CONNECTICUT DEPARTMENT OF TRANSPORTATION STANDARD SPECIFICATIONS FOR ROADS, BRIDGES AND INCIDENTAL CONSTRUCTION, FORM 816, 2004 (INCLUDING ADDENDUMS AND SUPPLEMENTALS) UNLESS OTHERWISE SPECIFIED IN THE CONTRACT DOCUMENTS.
- 2. CTDOT STANDARD SHEETS: THE CONTRACTOR IS RESPONSIBLE FOR OBTAINING ALL OF THE CONNECTICUT DEPARTMENT OF TRANSPORTATION (CTDOT) STANDARD SHEETS THAT PERTAIN TO ANY OF THE WORK ON THIS PROJECT. THESE SHEETS CAN BE OBTAINED DIRECTLY FROM THE DEPARTMENT AND/OR DOWNLOADED FROM THE DEPARTMENT'S WEBSITE AT WWW.CT.GOV/DOT.
- 3. DATUM: HORIZONTAL CONTROL NAD 83 VERTICAL CONTROL - NAVD 88
- 4. DESIGN SPEED: 25 MPH.
- 5. MUTCD: ALL PERMANENT AND TEMPORARY TRAFFIC CONTROL DEVICES INCLUDING TRAFFIC SIGNS, CONSTRUCTION SIGNS, PAVEMENT MARKINGS, AND CHANNELIZATION DEVICES SHALL MEET THE REQUIREMENTS OF, AND BE INSTALLED/PLACED IN ACCORDANCE WITH, THE DIMENSIONS AND LOCATIONS SPECIFIED IN THE LATEST EDITION OF THE MANUAL ON UNIFORM TRAFFIC CONTROL DEVICES (MUTCD), AS INDICATED ON THE PLANS, OR AS DIRECTED BY THE ENGINEER.
- 6. REMOVED MATERIALS: THE BOROUGH OF NAUGATUCK WILL BE PROVIDED THE OPTION OF RETAINING THE POSSESSION OF ALL MATERIALS REMOVED OR EXCAVATED IN THE COURSE OF EXECUTING THIS PROJECT. ANY MATERIALS RETAINED BY THE BOROUGH SHALL BE DELIVERED TO A SITE WITHIN BOROUGH LIMITS AS DESIGNATED BY THE BOROUGH AT NO ADDITIONAL COST TO THE BOROUGH OF NAUGATUCK. ALL MATERIALS NOT RETAINED BY THE BOROUGH SHALL BE PROPERLY DISPOSED OF AT NO ADDITIONAL COST TO THE BOROUGH OF NAUGATUCK.
- 7. EXCAVATED MATERIALS: ANY EXCAVATED MATERIALS DEEMED BY THE ENGINEER AS BEING SUITABLE FOR RE-USE SHALL BE STOCKPILED ON THE JOB SITE AS DIRECTED BY THE ENGINEER FOR FUTURE USE AS BACKFILL. NO ADDITIONAL PAYMENT WILL BE MADE FOR STOCKPILING MATERIAL, FOR RE-USE AS BACKFILL, OR FOR THE REMOVAL OF SURPLUS STOCKPILED MATERIAL NOT UTILIZED ON THE PROJECT. THE COST OF STOCKPILING IS TO BE INCLUDED IN THE "STRUCTURE EXCAVATION EARTH" ITEM.
- 8. PAY ITEMS: TECHNICAL SPECIFICATIONS SHALL BE IN ACCORDANCE WITH STATE OF CONNECTICUT FORM 816 (SEE NOTE 1). SOME OF THESE TECHNICAL ITEMS HAVE BEEN COMBINED FOR PAYMENT PURPOSES, AND THEREFORE, PAYMENT WILL ONLY BE MADE ACCORDING TO THE PAY ITEMS LISTED IN THE BID DOCUMENT FORMS PROVIDED. ALL MATERIALS, TOOLS, EQUIPMENT AND LABOR REQUIRED TO COMPLETE THE WORK AS DETAILED ON THESE PLANS SHALL BE INCLUDED IN CONTRACT PAY ITEMS. ANY WORK NOT SPECIFICALLY LABELED BUT NECESSARY TO COMPLETE THE WORK SHALL BE CONSIDERED INCIDENTAL.
- 9. 'CALL BEFORE YOU DIG': EXISTING STORM DRAIN, SANITARY SEWER, GAS, ELECTRIC, TELECOMMUNICATIONS AND OTHER UTILITIES ARE SHOWN IN THEIR APPROXIMATE LOCATIONS ON THE PLANS. THE CONTRACTOR SHALL CONTACT 'CALL BEFORE YOU DIG' AT 811 (800-922-4455) 72 HOURS PRIOR TO BEGINNING ANY SUBSURFACE CONSTRUCTION ACTIVITIES TO DETERMINE THE LOCATIONS OF THESE AND ANY OTHER BURIED UTILITIES NOT SHOWN ON THE PLANS.
- 10. DRAINAGE STRUCTURES: STATIONS AND TOP OF FRAME (TF) ELEVATIONS ARE MEASURED FROM THE LONGITUDINAL CENTER OF EACH STRUCTURE AT THE FACE OF CURB OR EDGE OF PAVEMENT, WHICHEVER APPLIES.
- 11. UTILITIES: UTILITY DESIGN HAS BEEN COORDINATED WITH THE RESPECTIVE UTILITY COMPANIES FOR TELEPHONE, GAS, ELECTRIC, AND CABLE. THE CONTRACTOR SHALL UTILIZE THE FOLLOWING CONTACTS WHEN DIRECTED TO CONTACT UTILITIES:

FRONTIER COMMUNICATIONS - TELEPHONE TOM DELORENZO (203) 238-5202 OR GLEN MCCLOUD (203) 575-6703

EVERSOURCE ENERGY ROB PANTALONE - GAS (203) 596-3020 BRIAN MORGAN - ELECTRIC (203) 597-4233

COMCAST - CABLE DAVE GERRISH (203) 732-0146 EXT. 73801

12. EXCAVATION: FINAL EXCAVATION LIMITS SHALL BE DETERMINED IN THE FIELD, BY APPROVAL OF THE ENGINEER. WHERE PAYMENT IS NOT OTHERWISE SPECIFIED, PAYMENT SHALL BE UNDER THE "EARTH EXCAVATION", "ROCK EXCAVATION" OR "REMOVE EXISTING MASONRY" ITEMS, AS APPROVED BY THE ENGINEER.

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					THE INFORMATION, INCLUDING ESTIMATED					
					QUANTITIES OF WORK, SHOWN ON THESE SHEETS IS BASED ON LIMITED	CHECKED BY:				
					INVESTIGATIONS BY THE STATE AND IS					
					IN NO WAY WARRANTED TO INDICATE THE CONDITIONS OF ACTUAL QUANTITIES OF WORK WHICH WILL BE REQUIRED.					
					OF WORK WHICH WILL BE REGULED.	SCAL				
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BOROUGH OF NAUGATUCK DEPARTMENT OF PUBLIC WORKS

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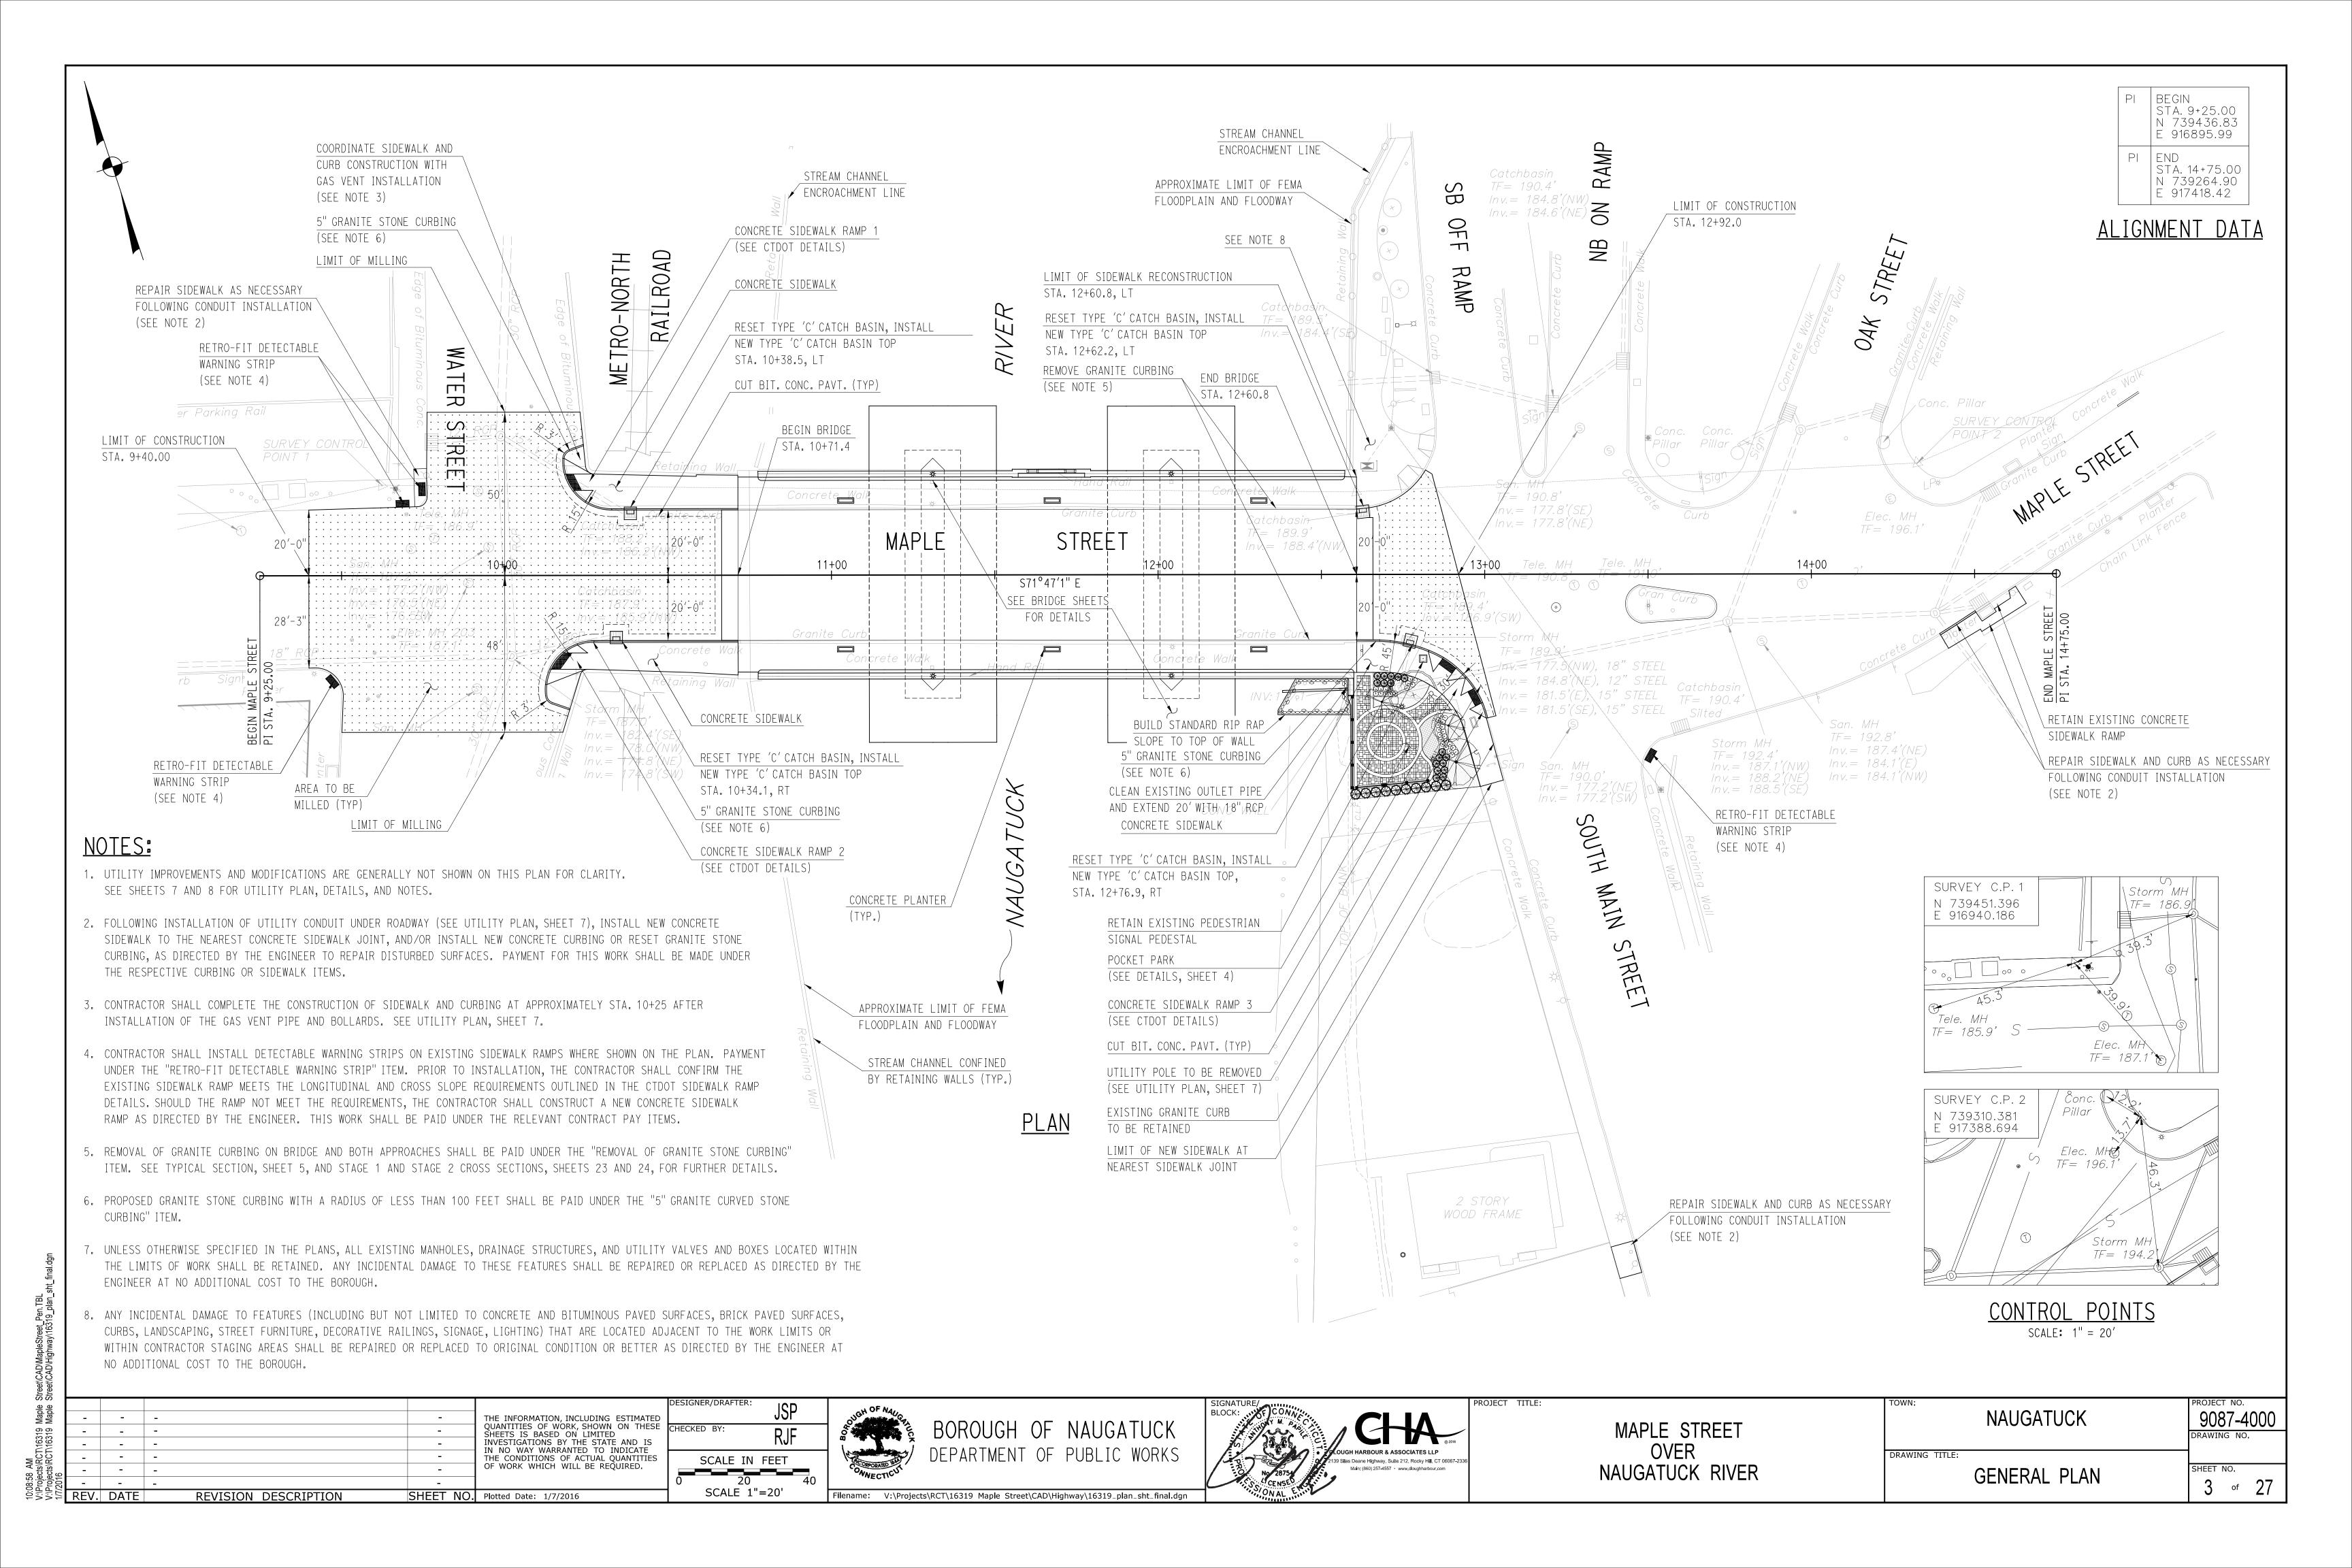
MAPLE STREET OVER NAUGATUCK RIVER


NAUGATUCK GENERAL NOTES


AND QUANTITIES

DRAWING TITLE

9087-4000 DRAWING NO. SHEET NO. 2 of 27




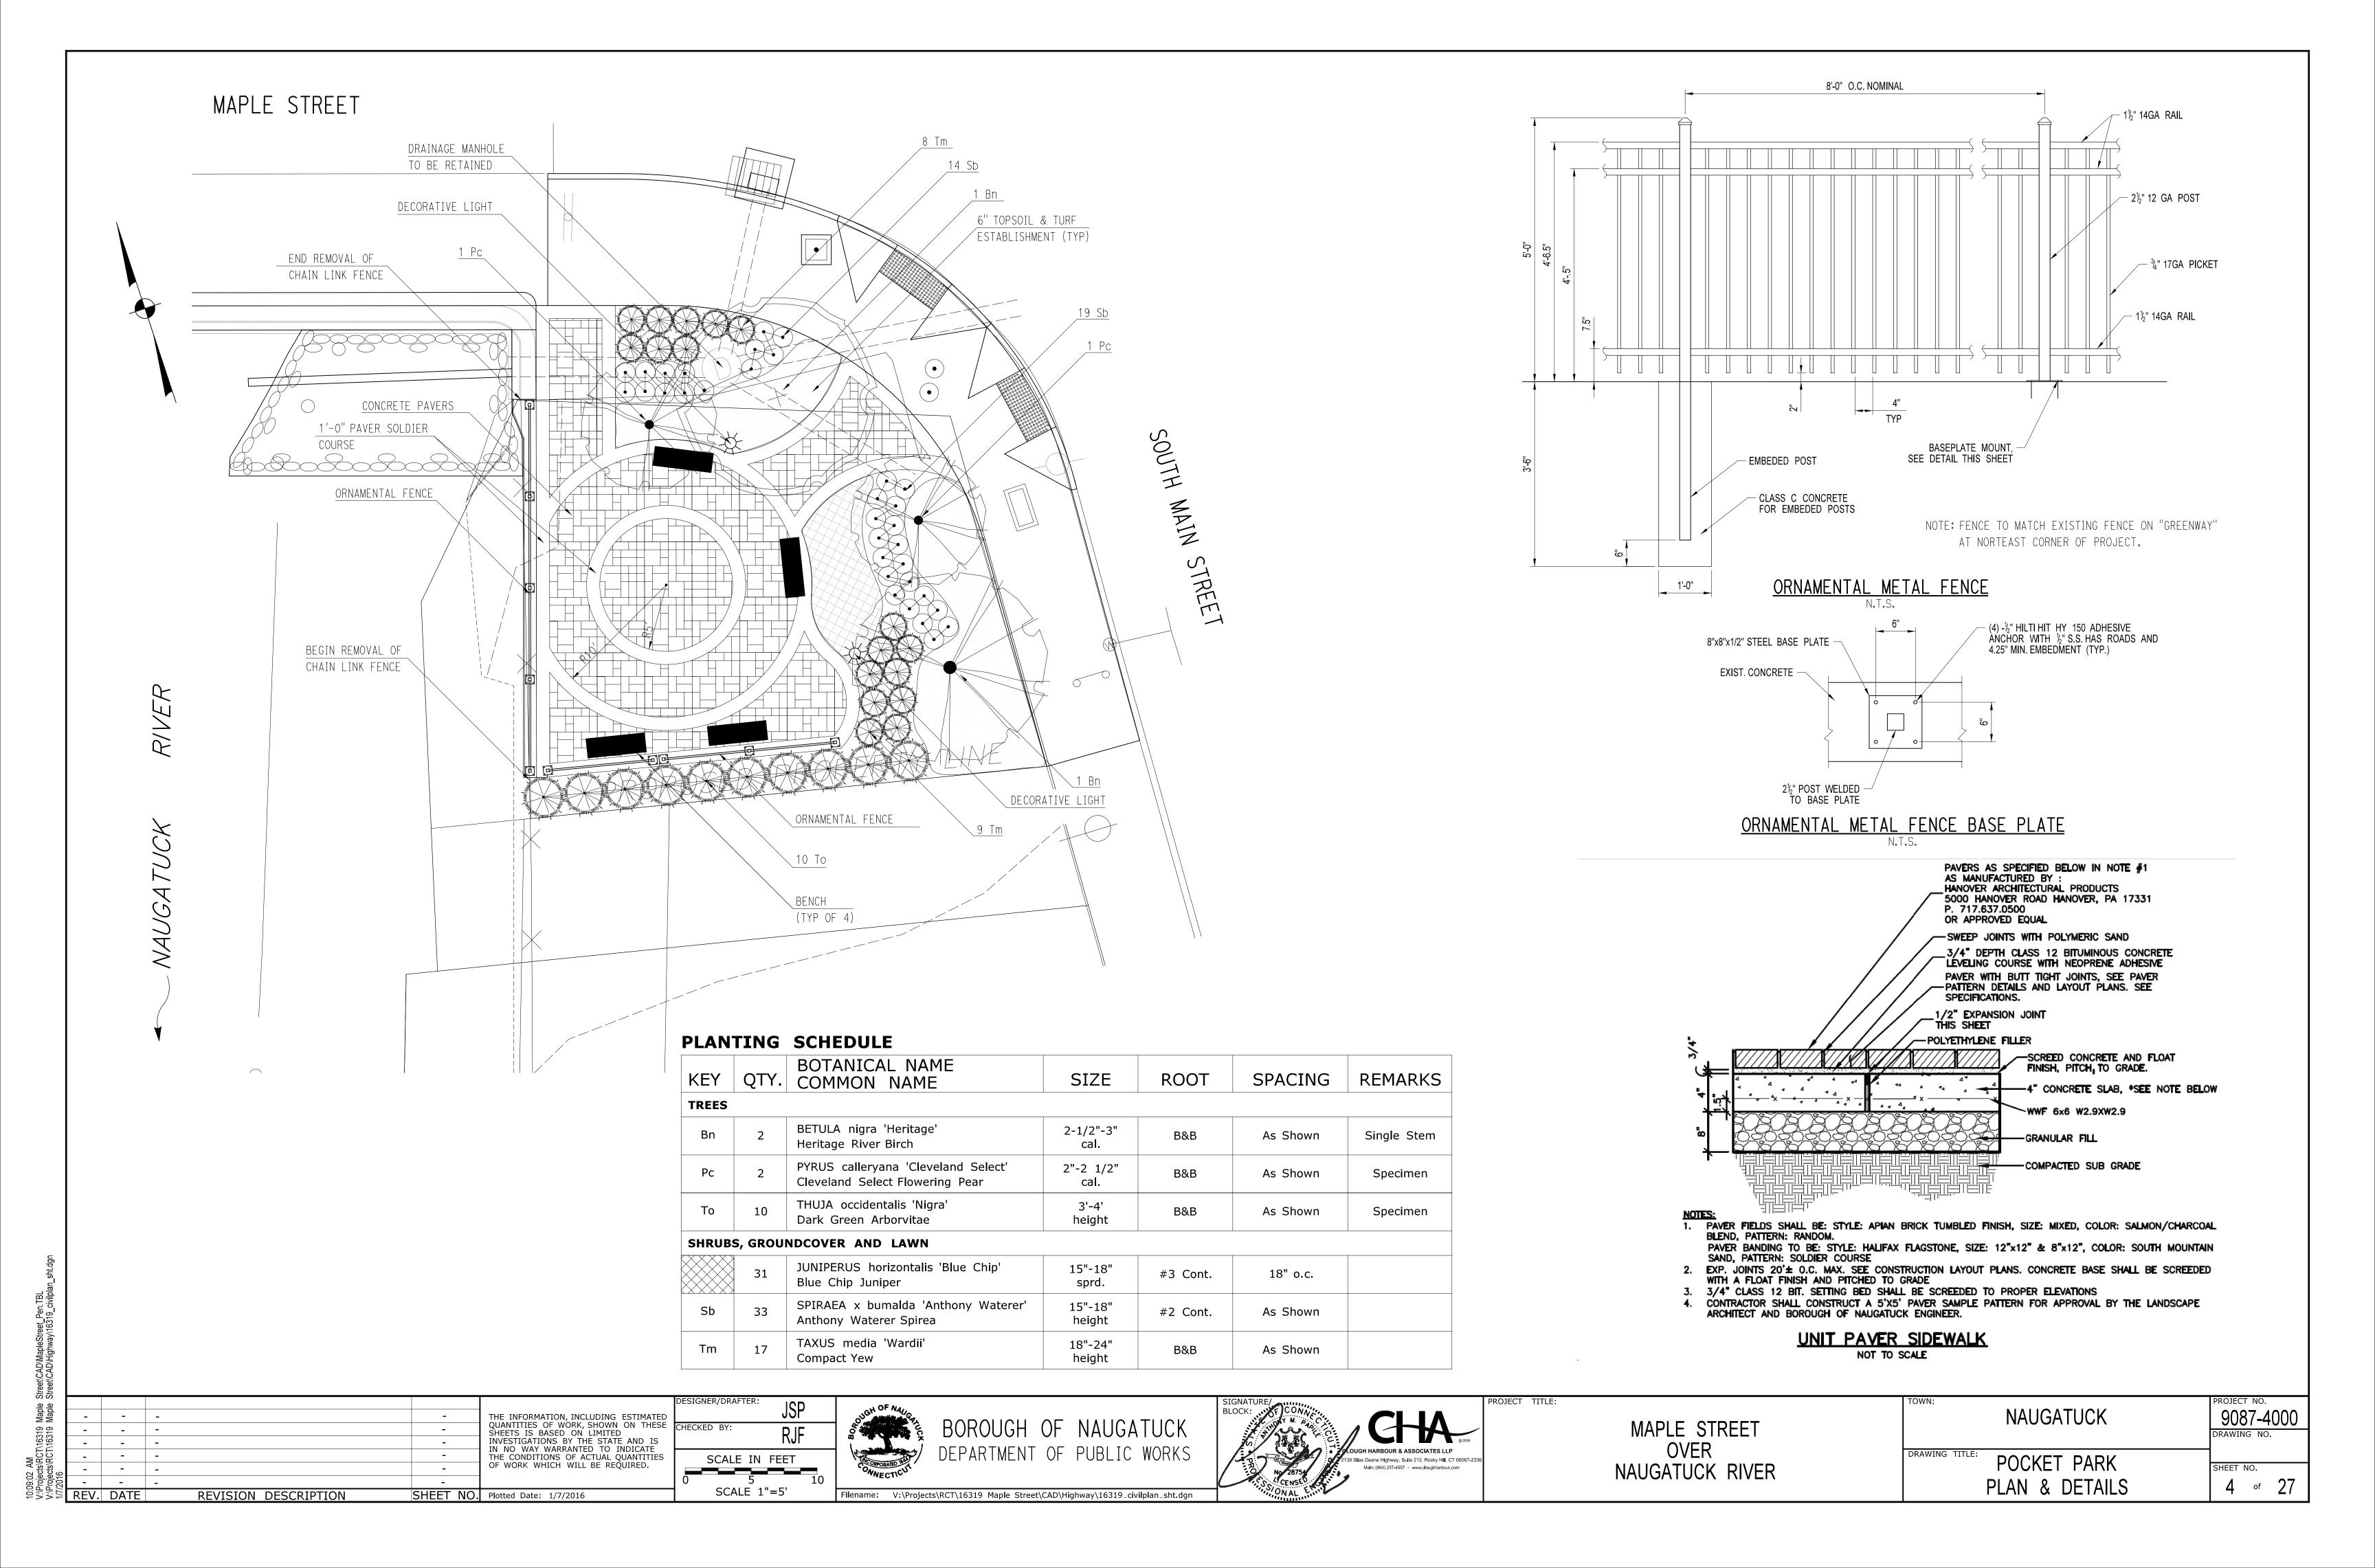

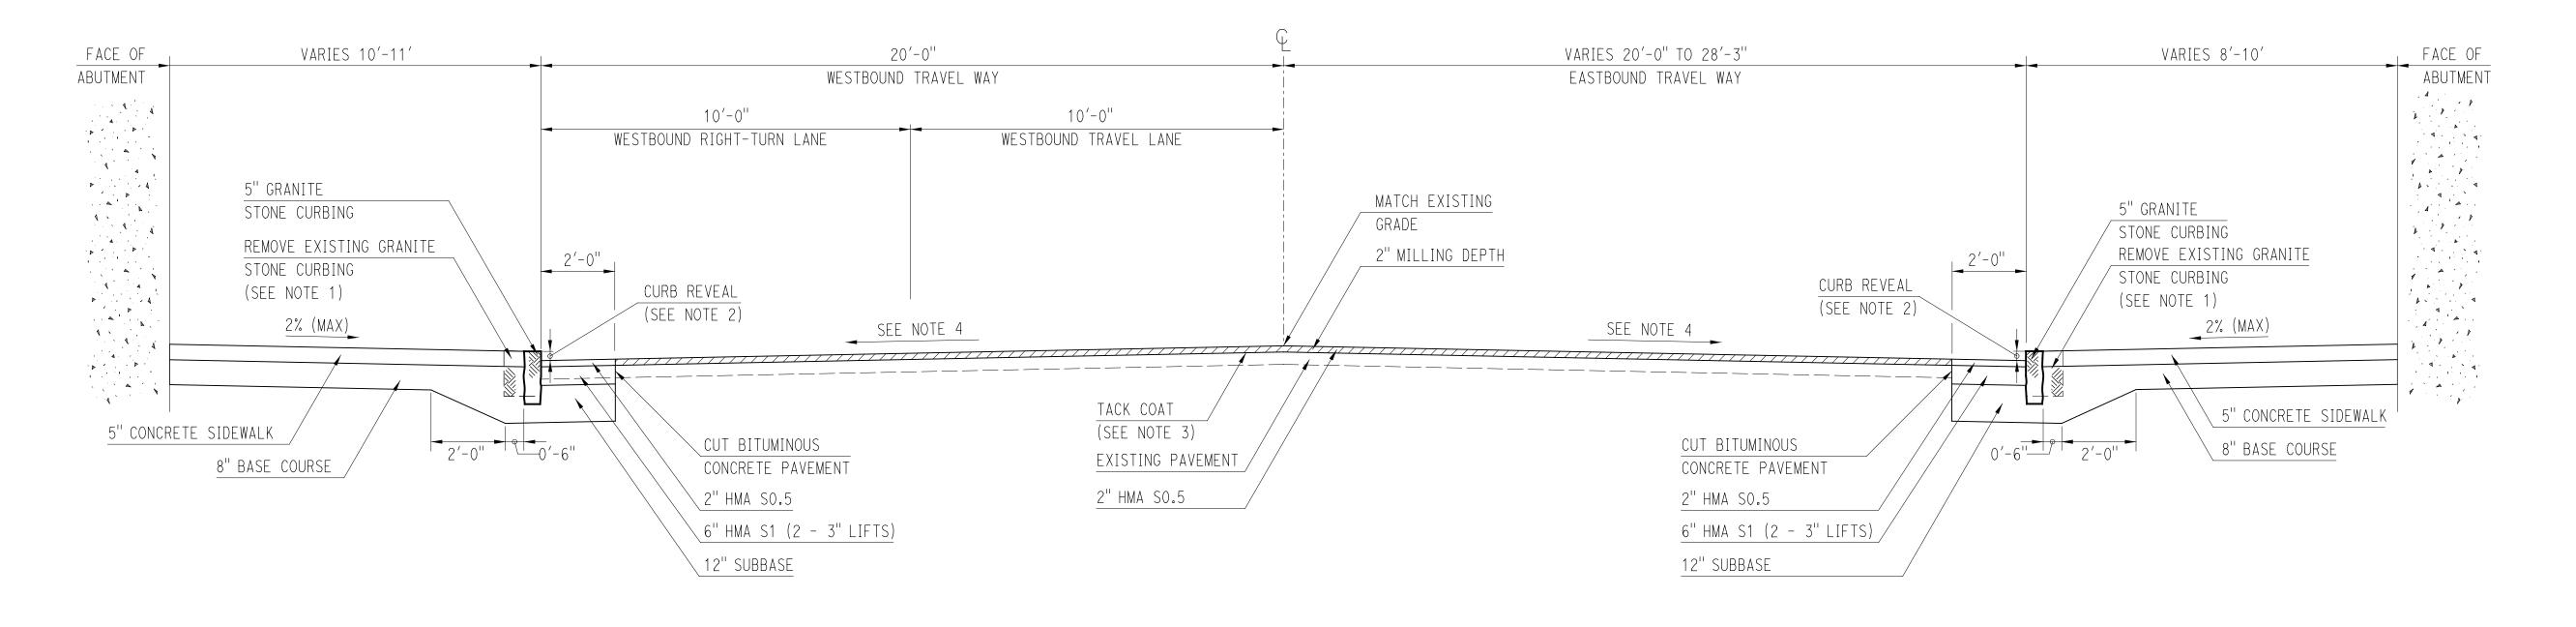

TYPICAL SECTION - WEST APPROACH MAPLE STREET

STA. 9+40.0 TO STA. 10+64.4 NOT TO SCALE

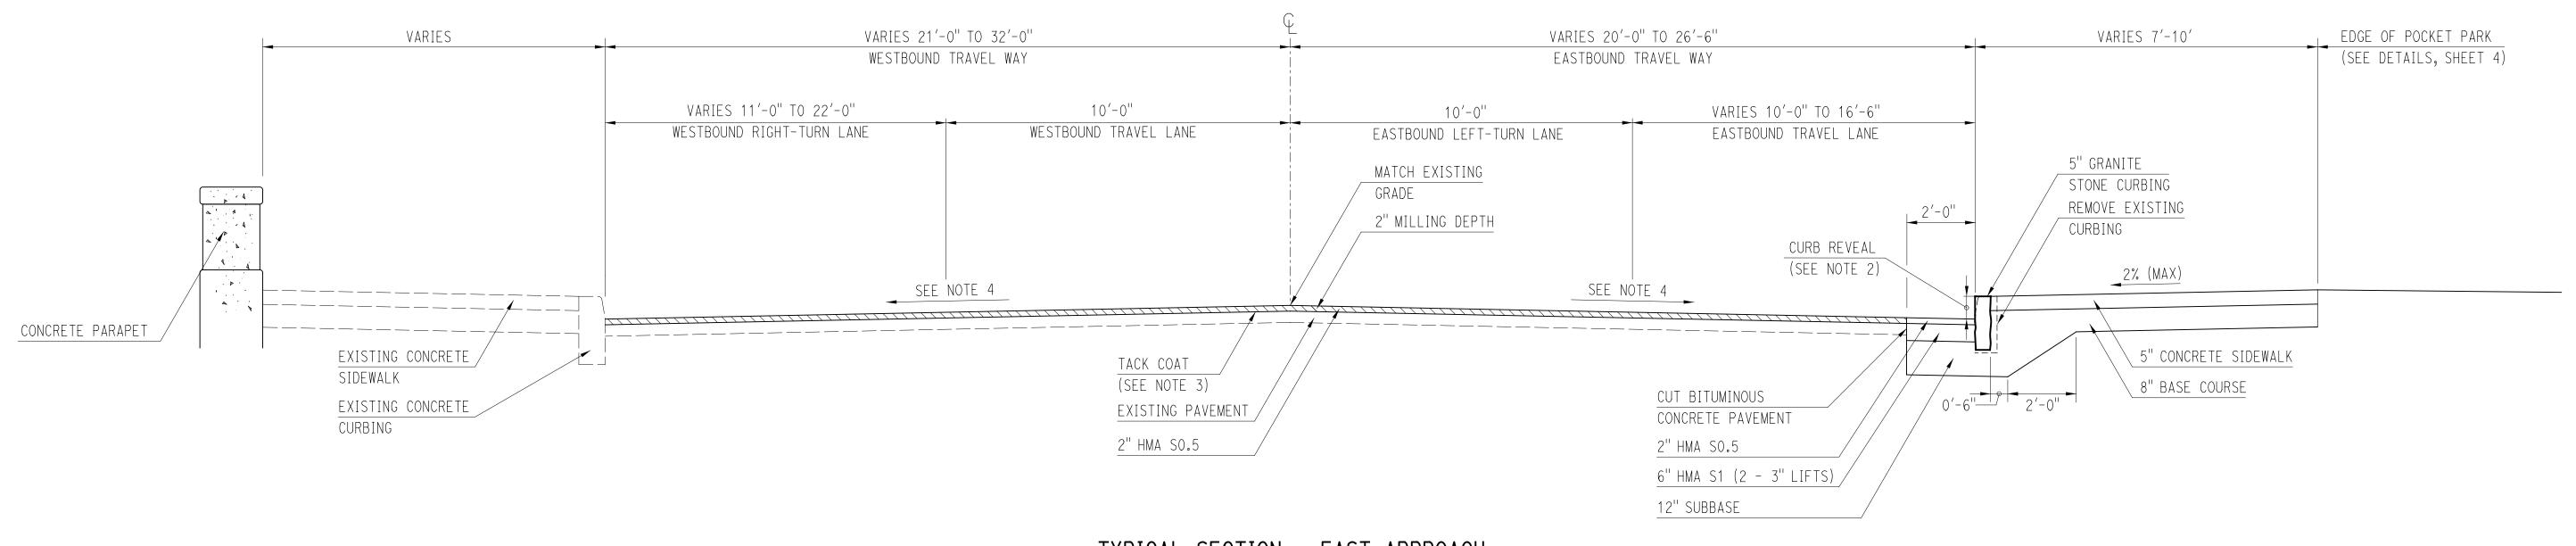


TYPICAL SECTION - EAST APPROACH MAPLE STREET


STA. 12+67.8 TO STA. 12+92.0 NOT TO SCALE

NOTES:

- 1. REMOVE AND SALVAGE EXISTING GRANITE STONE CURBING. THE CONTRACTOR SHALL DELIVER THE SALVAGED CURBING TO A LOCATION SPECIFIED BY THE BOROUGH OF NAUGATUCK OR AS DIRECTED BY THE ENGINEER.
- 2. TRANSITION CURB REVEAL FROM 3 INCHES AT BEGIN/END BRIDGE TO 6 INCHES OVER A MINIMUM DISTANCE OF 12 FEET.
- 3. TACK COAT TO BE APPLIED AT A RATE OF 0.07 GALLONS PER SQUARE YARD TO ALL MILLED SURFACES, SURFACES THAT HAVE BEEN IN PLACE LONGER THAN FIVE DAYS, AND ON ANY COLD JOINT, PRIOR TO ANY PAVING OPERATION. PAYMENT UNDER THE "MATERIAL FOR TACK COAT" ITEM.
- 4. MATCH EXISTING TRAVEL WAY CROSS SLOPE AT STA. 9+40.0, TRANSITION TO 2% AT STA. 10+64.4. TRANSITION CROSS SLOPE FROM 2% AT STA. 12+67.8 TO MATCH EXISTING AT STA. 12+92.

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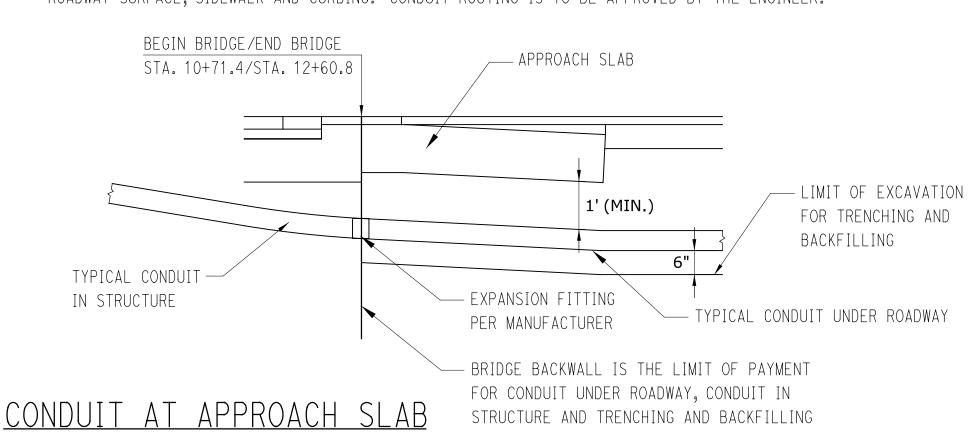


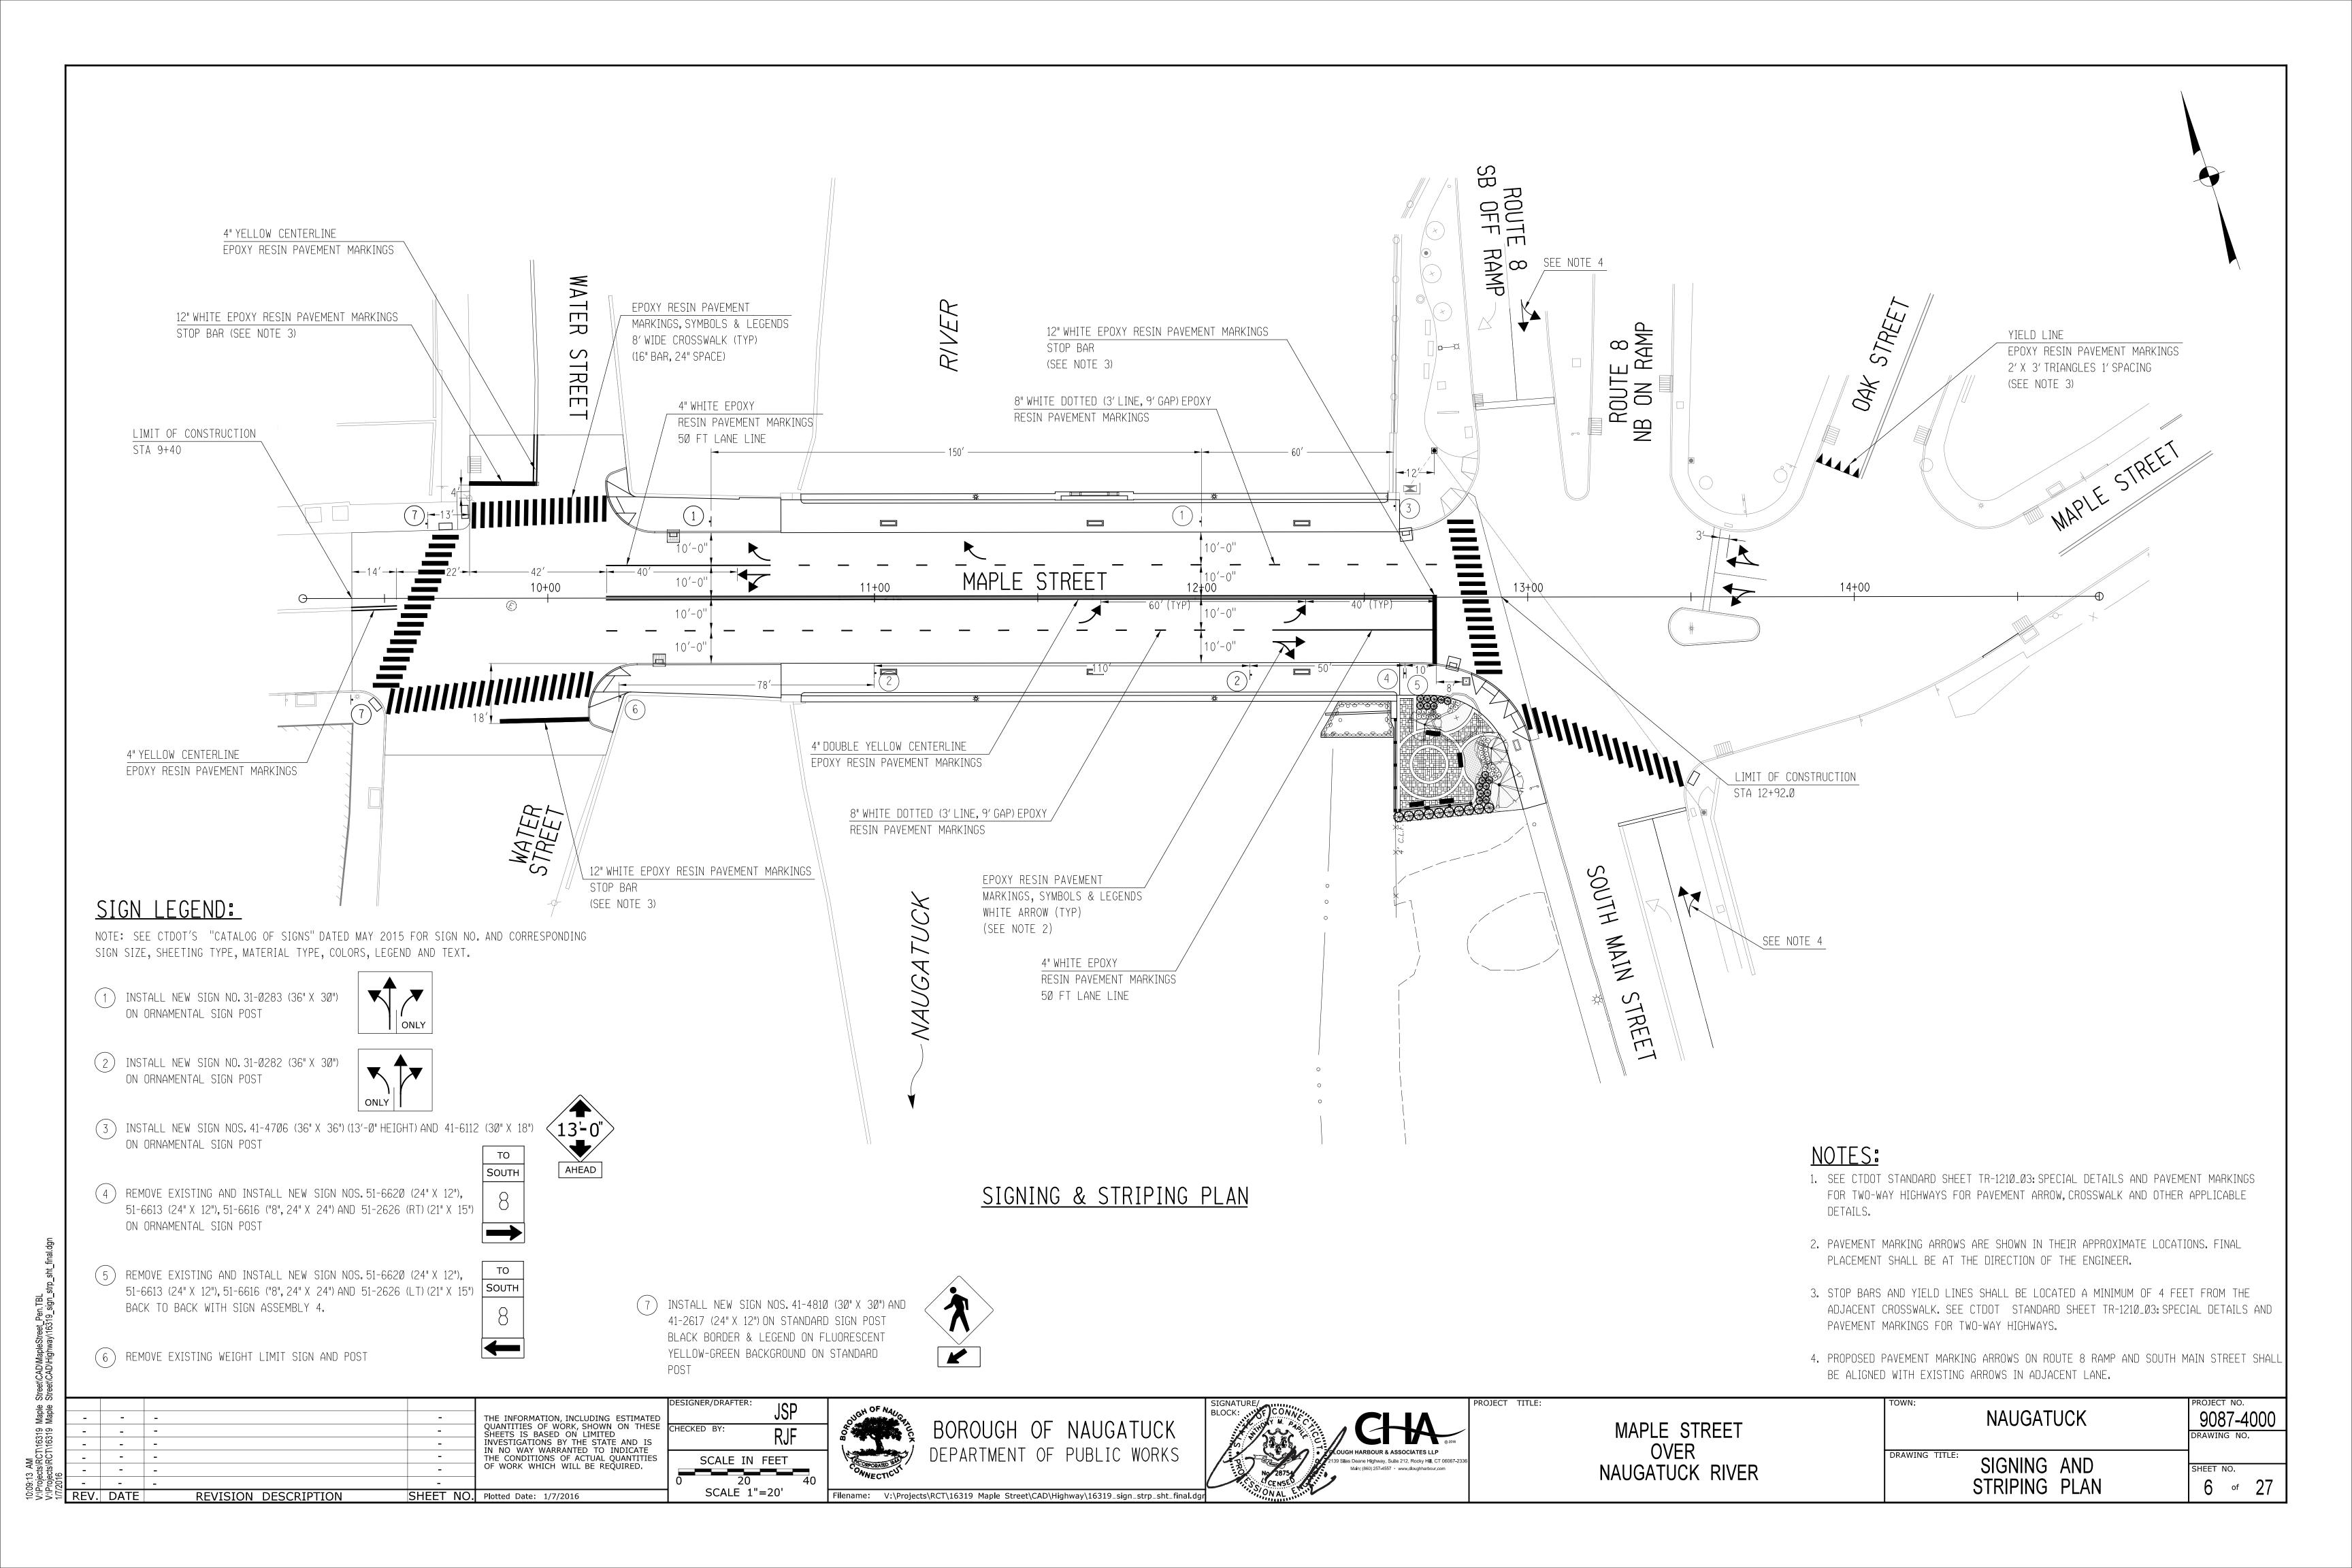

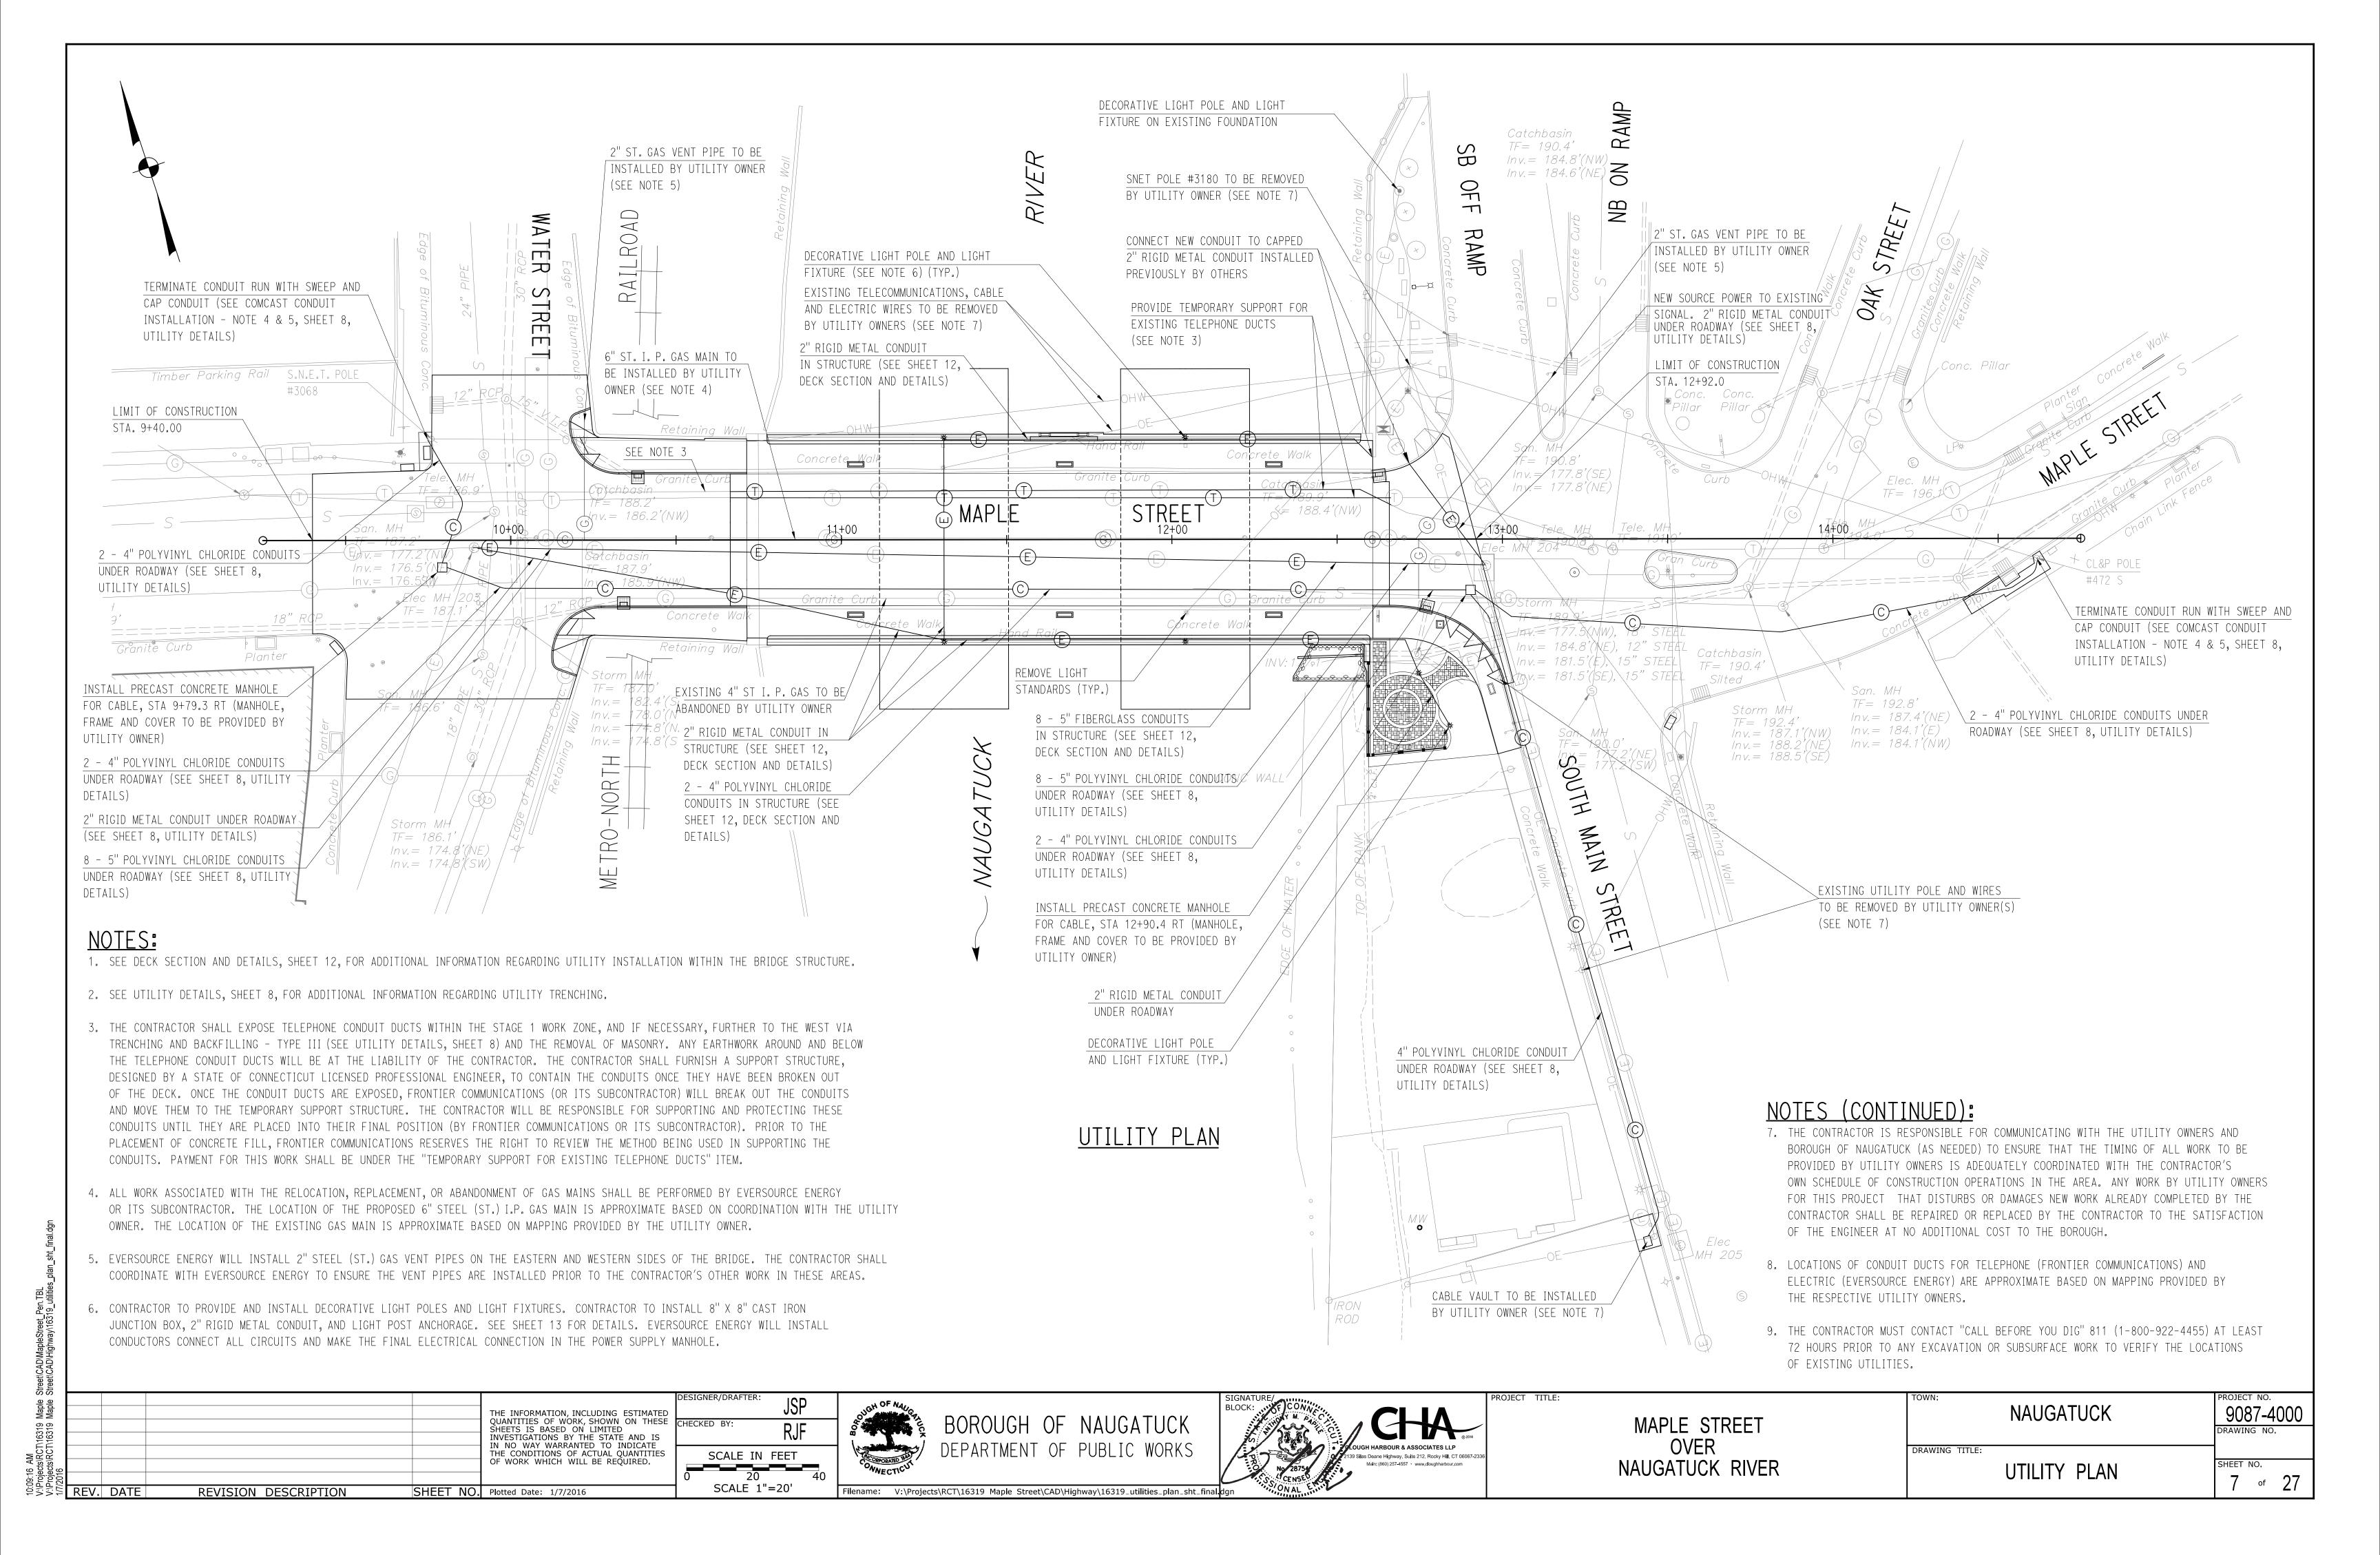4" POLYVINYL CHLORIDE CONDUITS UNDER ROADWAY

COMCAST CONDUIT INSTALLATION NOTES:


- 1. COMCAST CONDUIT RUNS MAY REQUIRE CROSSING TELEPHONE CONDUIT DUCTS, SANITARY AND STORM SEWER LINES, ELECTRICAL CONDUIT DUCTS, GAS MAINS AND OTHER UTILITIES. A MINIMUM OF 6 INCHES OF SEPARATION SHALL BE PROVIDED BY VARYING THE DEPTH OF THE COMCAST CONDUITS OR OTHER PROPOSED CONDUITS. THE WORK AND MATERIALS USED IN CONSTRUCTING THESE CROSSINGS SHALL BE INCLUDED IN THE "4" POLYVINYL CHLORIDE CONDUIT UNDER ROADWAY" ITEM.
- 2. WHEN MORE THAN ONE CONDUIT RUN IS PROVIDED IN A SINGLE TRENCH, CONDUITS SHALL BE ALIGNED SIDE BY SIDE AND SEPARATED BY A MINIMUM OF 4 INCHES.
- 3. 4" PVC CONDUIT SHALL BE PAID UNDER THE "4" POLYVINYL CHLORIDE CONDUIT UNDER ROADWAY" ITEM. ALL INCIDENTAL MATERIALS RELATED TO CONDUIT (FITTINGS, SWEEPS, PULL ROPE, ETC.) SHALL BE INCLUDED IN THE "4" POLYVINYL CHLORIDE CONDUIT UNDER ROADWAY" ITEM. THIS WORK SHALL CONFORM TO THE SPECIAL PROVISIONS.
- 4. CUTTING OF BITUMINOUS CONCRETE PAVEMENT, REMOVAL OF PAVEMENT/SIDEWALK, TRENCH EXCAVATION, PLACEMENT OF SAND BEDDING MATERIAL, INSTALLATION OF WARNING TAPE, AND PLACEMENT OF SUBBASE FOR THE INSTALLATION OF 4" PVC CONDUIT UNDER ROADWAY, SHALL BE PAID UNDER THE "TRENCHING AND BACKFILLING, TYPE I" ITEM. THIS WORK SHALL CONFORM TO THE SPECIAL PROVISIONS. HMA SO.5, HMA S1, 5" CONCRETE SIDEWALK (WITH 8" BASE COURSE), AND REMOVAL AND RESETTING OF GRANITE STONE CURBING, AND CONCRETE CURBING ITEMS, AS REQUIRED FOR CONDUIT INSTALLATION, WILL BE PAID UNDER THEIR RESPECTIVE CONTRACT PAY ITEMS. ANY OTHER WORK THAT IS REQUIRED TO REPAIR DISTURBED AREAS FOR CONDUIT INSTALLATION SHALL BE AS DIRECTED BY THE ENGINEER AND PAYMENT WILL BE INCIDENTAL TO OTHER CONTRACT ITEMS.
- 5. CONDUIT SHALL BE BROUGHT ABOVE GROUND AND CAPPED AT SNET POLE #3068 AND CL&P POLE #472S VIA 24" PVC SWEEPS, INCIDENTAL TO THE "4" POLYVINYL CHLORIDE CONDUIT UNDER ROADWAY" ITEM. CONDUITS SHALL BE CAPPED AT ALL MANHOLE LOCATIONS; COMCAST TO MAKE FINAL CONNECTIONS.
- 6. ADJUST ROUTING OF CONDUIT BETWEEN PROPOSED COMCAST MANHOLE AT STA. 12+90 RT AND THE PROPOSED COMCAST VAULT ON SOUTH MAIN STREET TO AVOID EXISTING UTILITIES. THE CONTRACTOR SHALL EXERCISE CARE TO AVOID IMPACTS TO ADJACENT UTILITIES AND TO MINIMIZE IMPACTS AND DISTURBANCE OF THE EXISTING ROADWAY SURFACE, SIDEWALK AND CURBING. CONDUIT ROUTING IS TO BE APPROVED BY THE ENGINEER.



CONDUIT AT APPROACH SLAB NOTES

REVISION DESCRIPTION


1. ALL CONDUIT FITTINGS AND JOINTS SHALL BE APPROVED BY THE CONDUIT MANUFACTURER FOR USE WITH THE TYPE OF CONDUIT. THIS WORK SHALL CONFORM TO THE SPECIAL PROVISIONS.

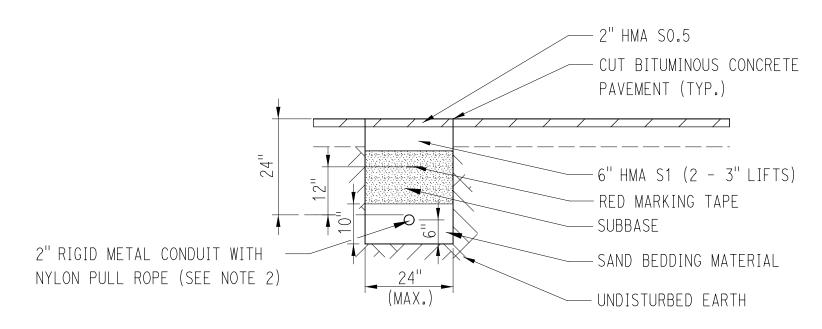

2" RIGID METAL CONDUIT UNDER ROADWAY


RIGID METAL CONDUIT INSTALLATION NOTES:

- 1. RIGID METAL CONDUIT RUNS MAY REQUIRE CROSSING TELEPHONE CONDUIT DUCTS, SANITARY AND STORM SEWER LINES, ELECTRICAL CONDUIT DUCTS, GAS MAINS AND OTHER UTILITIES. A MINIMUM OF 6 INCHES OF SEPARATION SHALL BE PROVIDED BY VARYING THE DEPTH OF THE RIGID METAL CONDUIT OR OTHER PROPOSED CONDUITS. THE WORK AND MATERIALS USED IN CONSTRUCTING THESE CROSSINGS SHALL BE INCLUDED IN THE "2" RIGID METAL CONDUIT UNDER ROADWAY" ITEM.
- 2. 2" RIGID METAL CONDUIT SHALL BE PAID UNDER THE "2" RIGID METAL CONDUIT UNDER ROADWAY" ITEM. ALL INCIDENTAL MATERIALS RELATED TO CONDUIT (FITTINGS, SWEEPS, PULL ROPE, ETC.) SHALL BE INCLUDED IN THIS ITEM. THIS WORK SHALL CONFORM TO THE SPECIAL PROVISIONS.
- 3. CUTTING OF BITUMINOUS CONCRETE PAVEMENT, TRENCH EXCAVATION, PLACEMENT OF SAND BEDDING MATERIAL, INSTALLATION OF MARKING TAPE, AND PLACEMENT OF SUBBASE FOR THE INSTALLATION OF 2" RIGID METAL CONDUIT UNDER ROADWAY SHALL BE PAID UNDER THE "TRENCHING AND BACKFILLING, TYPE I" ITEM. THIS WORK SHALL CONFORM TO THE SPECIAL PROVISIONS.
- 4. HMA SO.5, HMA S1, SIDEWALK AND CURBING ITEMS, AS REQUIRED FOR CONDUIT INSTALLATION, WILL BE PAID UNDER THEIR RESPECTIVE CONTRACT PAY ITEMS. ANY OTHER WORK THAT IS REQUIRED TO FACILITATE CONDUIT INSTALLATION SHALL BE AS DIRECTED BY THE ENGINEER AND PAYMENT WILL BE INCIDENTAL TO OTHER CONTRACT ITEMS.
- 5. THE CONTRACTOR SHALL EXERCISE CARE TO AVOID INCIDENTAL IMPACTS TO ADJACENT UTILITIES AND TO MINIMIZE IMPACTS AND DISTURBANCE OF THE EXISTING ROADWAY SURFACE, SIDEWALKS, AND CURBING. CONDUIT ROUTING AND LIMITS OF EXCAVATION FOR THE PURPOSES OF PAYMENT ARE TO BE APPROVED BY THE ENGINEER.
- 6. CONDUIT SHALL BE INSTALLED TO AN AREA APPROXIMATELY 2 FEET FROM ELEC. MANHOLES #203 AND #204 AND CAPPED. CONDUIT ENTRY INTO THE MANHOLES SHALL BE PERFORMED BY EVERSOURCE ENERGY (OR ITS SUBCONTRACTOR). THE CONTRACTOR SHALL COORDINATE THIS WORK WITH EVERSOURCE ENERGY PRIOR TO BACKFILLING. ALL COORDINATION SHALL BE CONSIDERED INCIDENTAL TO THE "2" RIGID METAL CONDUIT UNDER ROADWAY" ITEM. EVERSOURCE ENERGY SHALL PULL ELECTRICAL CABLES THROUGH CONDUIT FOLLOWING ACCEPTANCE OF CONDUIT INSTALLATION.

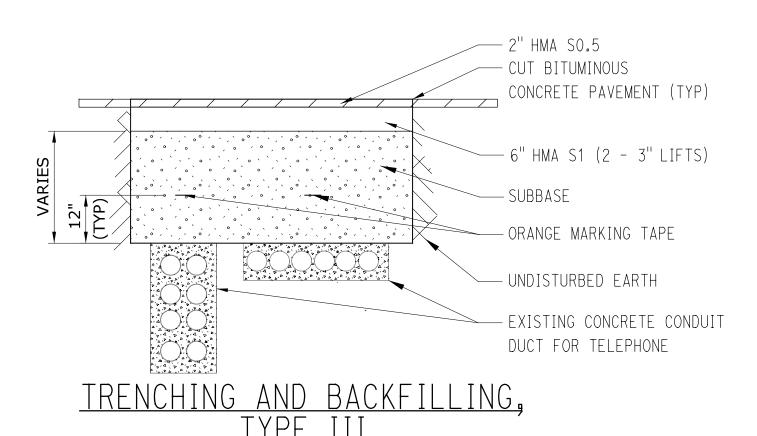

TRENCHING AND BACKFILLING. TYPE III NOTES:

- 1. THE DEPTH OF THE EXISTING TELEPHONE CONDUIT DUCTS IS UNKNOWN. THE CONTRACTOR SHALL EXPOSE THE CONCRETE CONDUIT DUCTS AS DIRECTED BY THE ENGINEER IN ORDER TO REPOSITION THE CONDUITS FOR TEMPORARY SUPPORT ON THE BRIDGE. LIMITS OF TRENCHING AND BACKFILLING, TYPE III SHALL BE DETERMINED IN THE FIELD, A QUANTITY HAS BEEN INCLUDED FOR BIDDING PURPOSES.
- 2. THE CONTRACTOR SHALL NOT ATTEMPT TO EXCAVATE AROUND OR BELOW THE EXPOSED CONCRETE CONDUIT DUCT. THE CONTRACTOR WILL BE RESPONSIBLE FOR ANY DAMAGE CAUSED TO THE CONDUITS BY ANY EXCAVATION AROUND THE CONDUITS NOT AUTHORIZED BY THE ENGINEER.
- 3. CUTTING OF BITUMINOUS CONCRETE PAVEMENT, TRENCH EXCAVATION, INSTALLATION OF MARKING TAPE, AND PLACEMENT OF SUBBASE SHALL BE PAID UNDER THE "TRENCHING AND BACKFILLING, TYPE III" ITEM. THIS WORK SHALL CONFORM TO THE SPECIAL PROVISIONS. HMA SO.5 AND HMA S1 FOR CLOSING THE TRENCH SHALL BE PAID UNDER THEIR RESPECTIVE CONTRACT PAY ITEMS.
- 4. THE CONTRACTOR SHALL COORDINATE THIS WORK WITH FRONTIER COMMUNICATIONS. COORDINATION WITH FRONTIER SHALL BE CONSIDERED INCIDENTAL TO THE "TEMPORARY UPPORT FOR EXISTING TELEPHONE DUCTS" ITEM. FRONTIER (OR ITS SUBCONTRACTOR) WILL BREAK OUT AND MOVE THE CONDUITS FOLLOWING THE TRENCH EXCAVATION WORK. THE CONTRACTOR SHALL BACKFILL THE TRENCH AFTER FRONTIER COMMUNICATIONS RESTORES THE CONDUITS IN THEIR FINAL LOCATION.

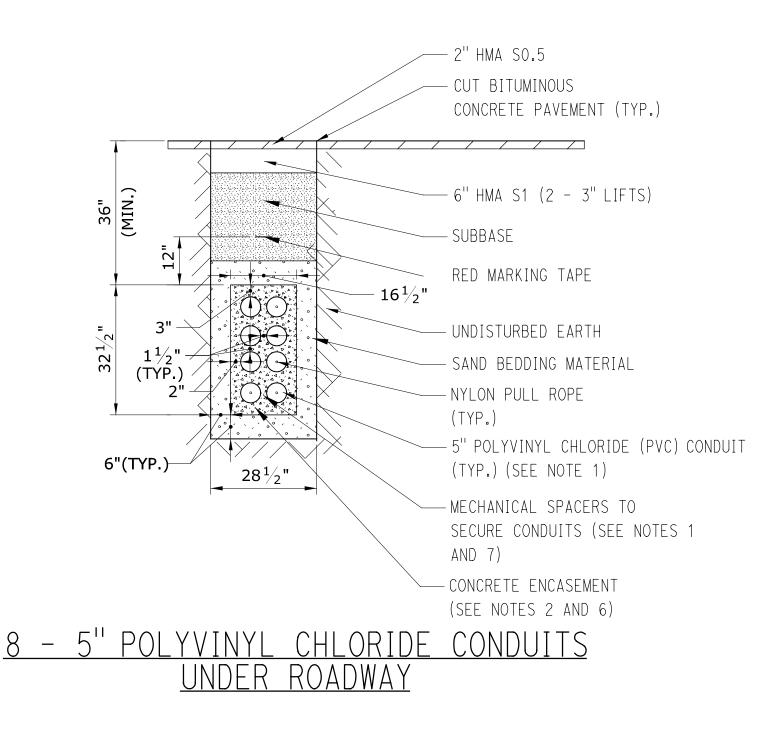

EVERSOURCE ENERGY CONDUIT INSTALLATION NOTES:

- 1. 5" PVC CONDUIT SHALL BE PAID UNDER THE "5" POLYVINYL CHLORIDE CONDUIT UNDER ROADWAY" ITEM. ALL INCIDENTAL MATERIALS RELATED TO CONDUIT (FITTINGS, SWEEPS, SLEEVES, SPACERS, ETC.) SHALL BE INCLUDED IN THIS ITEM. THIS WORK SHALL CONFORM TO THE SPECIAL PROVISIONS. THE PRODUCT SHALL BE APPROVED FOR USE BY EVERSOURCE ENERGY AND THE ENGINEER PRIOR TO CONSTRUCTION.
- 2. CUTTING OF BITUMINOUS CONCRETE PAVEMENT, TRENCH EXCAVATION, PLACEMENT OF SAND BEDDING MATERIAL AND CONCRETE ENCASEMENT, INSTALLATION OF MARKING TAPE, AND PLACEMENT OF SUBBASE FOR THE INSTALLATION OF 5" POLYVINYL CHLORIDE CONDUIT UNDER ROADWAY SHALL BE PAID UNDER THE "TRENCHING AND BACKFILLING, TYPE II" ITEM. THIS WORK SHALL CONFORM TO THE SPECIAL PROVISIONS.
- 3. HMA SO.5 AND HMA S1 FOR CONDUIT INSTALLATION WILL BE PAID UNDER THEIR RESPECTIVE CONTRACT PAY ITEMS. ANY OTHER WORK THAT IS REQUIRED TO FACILITATE CONDUIT INSTALLATION SHALL BE AS DIRECTED BY THE ENGINEER AND PAYMENT WILL BE INCIDENTAL TO OTHER CONTRACT ITEMS.
- 4. CONDUIT SHALL BE INSTALLED TO AN AREA APPROXIMATELY 2 FEET FROM ELEC. MANHOLES #203 AND #204 AND CAPPED. CONDUIT ENTRY INTO MANHOLES SHALL BE PERFORMED BY EVERSOURCE ENERGY (OR ITS SUBCONTRACTOR). THE CONTRACTOR SHALL COORDINATE THIS WORK WITH EVERSOURCE ENERGY PRIOR TO BACKFILLING. COORDINATION SHALL BE CONSIDERED INCIDENTAL TO THE "5" POLYVINYL CHLORIDE CONDUIT UNDER ROADWAY" ITEM. EVERSOURCE ENERGY SHALL PULL ELECTRICAL CABLES THROUGH THE CONDUITS FOLLOWING ACCEPTANCE OF THE CONDUIT INSTALLATION.
- 5. THE VERTICAL ALIGNMENT OF THE CONDUIT DUCT IS TO BE VARIED AT THE DISCRETION OF THE ENGINEER TO AVOID GAS MAINS, SANITARY AND STORM SEWER LINES, AND OTHER UTILITIES. WHERE POSSIBLE, 1 FOOT OF VERTICAL SEPARATION SHALL BE PROVIDED BETWEEN UTILITIES; UNDER CONSTRAINED CONDITIONS, A MINIMUM OF 6 INCHES OF VERTICAL SEPARATION SHALL BE PROVIDED.
- 6. CONCRETE FOR ENCASEMENT SHALL BE 2500 PSI, ½INCH MAXIMUM STONE, 6-9 INCHES OF SLUMP OF SUCH CONSISTENCY THAT SPADING WILL ENSURE THE FLOW OF CONCRETE BETWEEN AND UNDER THE INDIVIDUAL DUCTS BUT NOT SO WET AS TO FLOAT THE DUCTS. FOR TIER BUILDUP CONSTRUCTION, A STIFFER CONSISTENCY SHOULD BE USED.
- 7. MECHANICAL SPACERS SHALL BE PROVIDED EVERY 8 LONGITUDINAL FEET (ON CENTER) OF CONDUIT INSTALLATION. SPACERS SHALL CONFORM TO THE SPECIAL PROVISIONS. SPACERS SHALL BE OF THE SAME MATERIAL AND TYPE AS, AND BE APPROVED FOR USE WITH, THE CONDUIT BEING INSTALLED. SPACERS SHALL BE INCIDENTAL TO THE "5" POLYVINYL CHLORIDE CONDUIT UNDER ROADWAY" ITEM.

THE INFORMATION, INCLUDING ESTIMATED QUANTITIES OF WORK, SHOWN ON THESE SHEETS IS BASED ON LIMITED INVESTIGATIONS BY THE STATE AND IS IN NO WAY WARRANTED TO INDICATE THE CONDITIONS OF ACTUAL QUANTITIES OF WORK WHICH WILL BE REQUIRED.

SHEET NO. Plotted Date: 1/7/2016

TER: JSP

RJF

SCALE AS NOTED

BOROUGH OF NAUGATUCK DEPARTMENT OF PUBLIC WORKS

JET / INCHMENT OF TOBETO HOTHIC



MAPLE STREET OVER NAUGATUCK RIVER NAUGATUCK

9087-4000


DRAWING NO.

WING TITLE:

SHEET NO.
8 of 27

Filename: V:\Projects\RCT\16319 Maple Street\CAD\Highway\16319_utility_details.dgn

DRAWING TITLE:

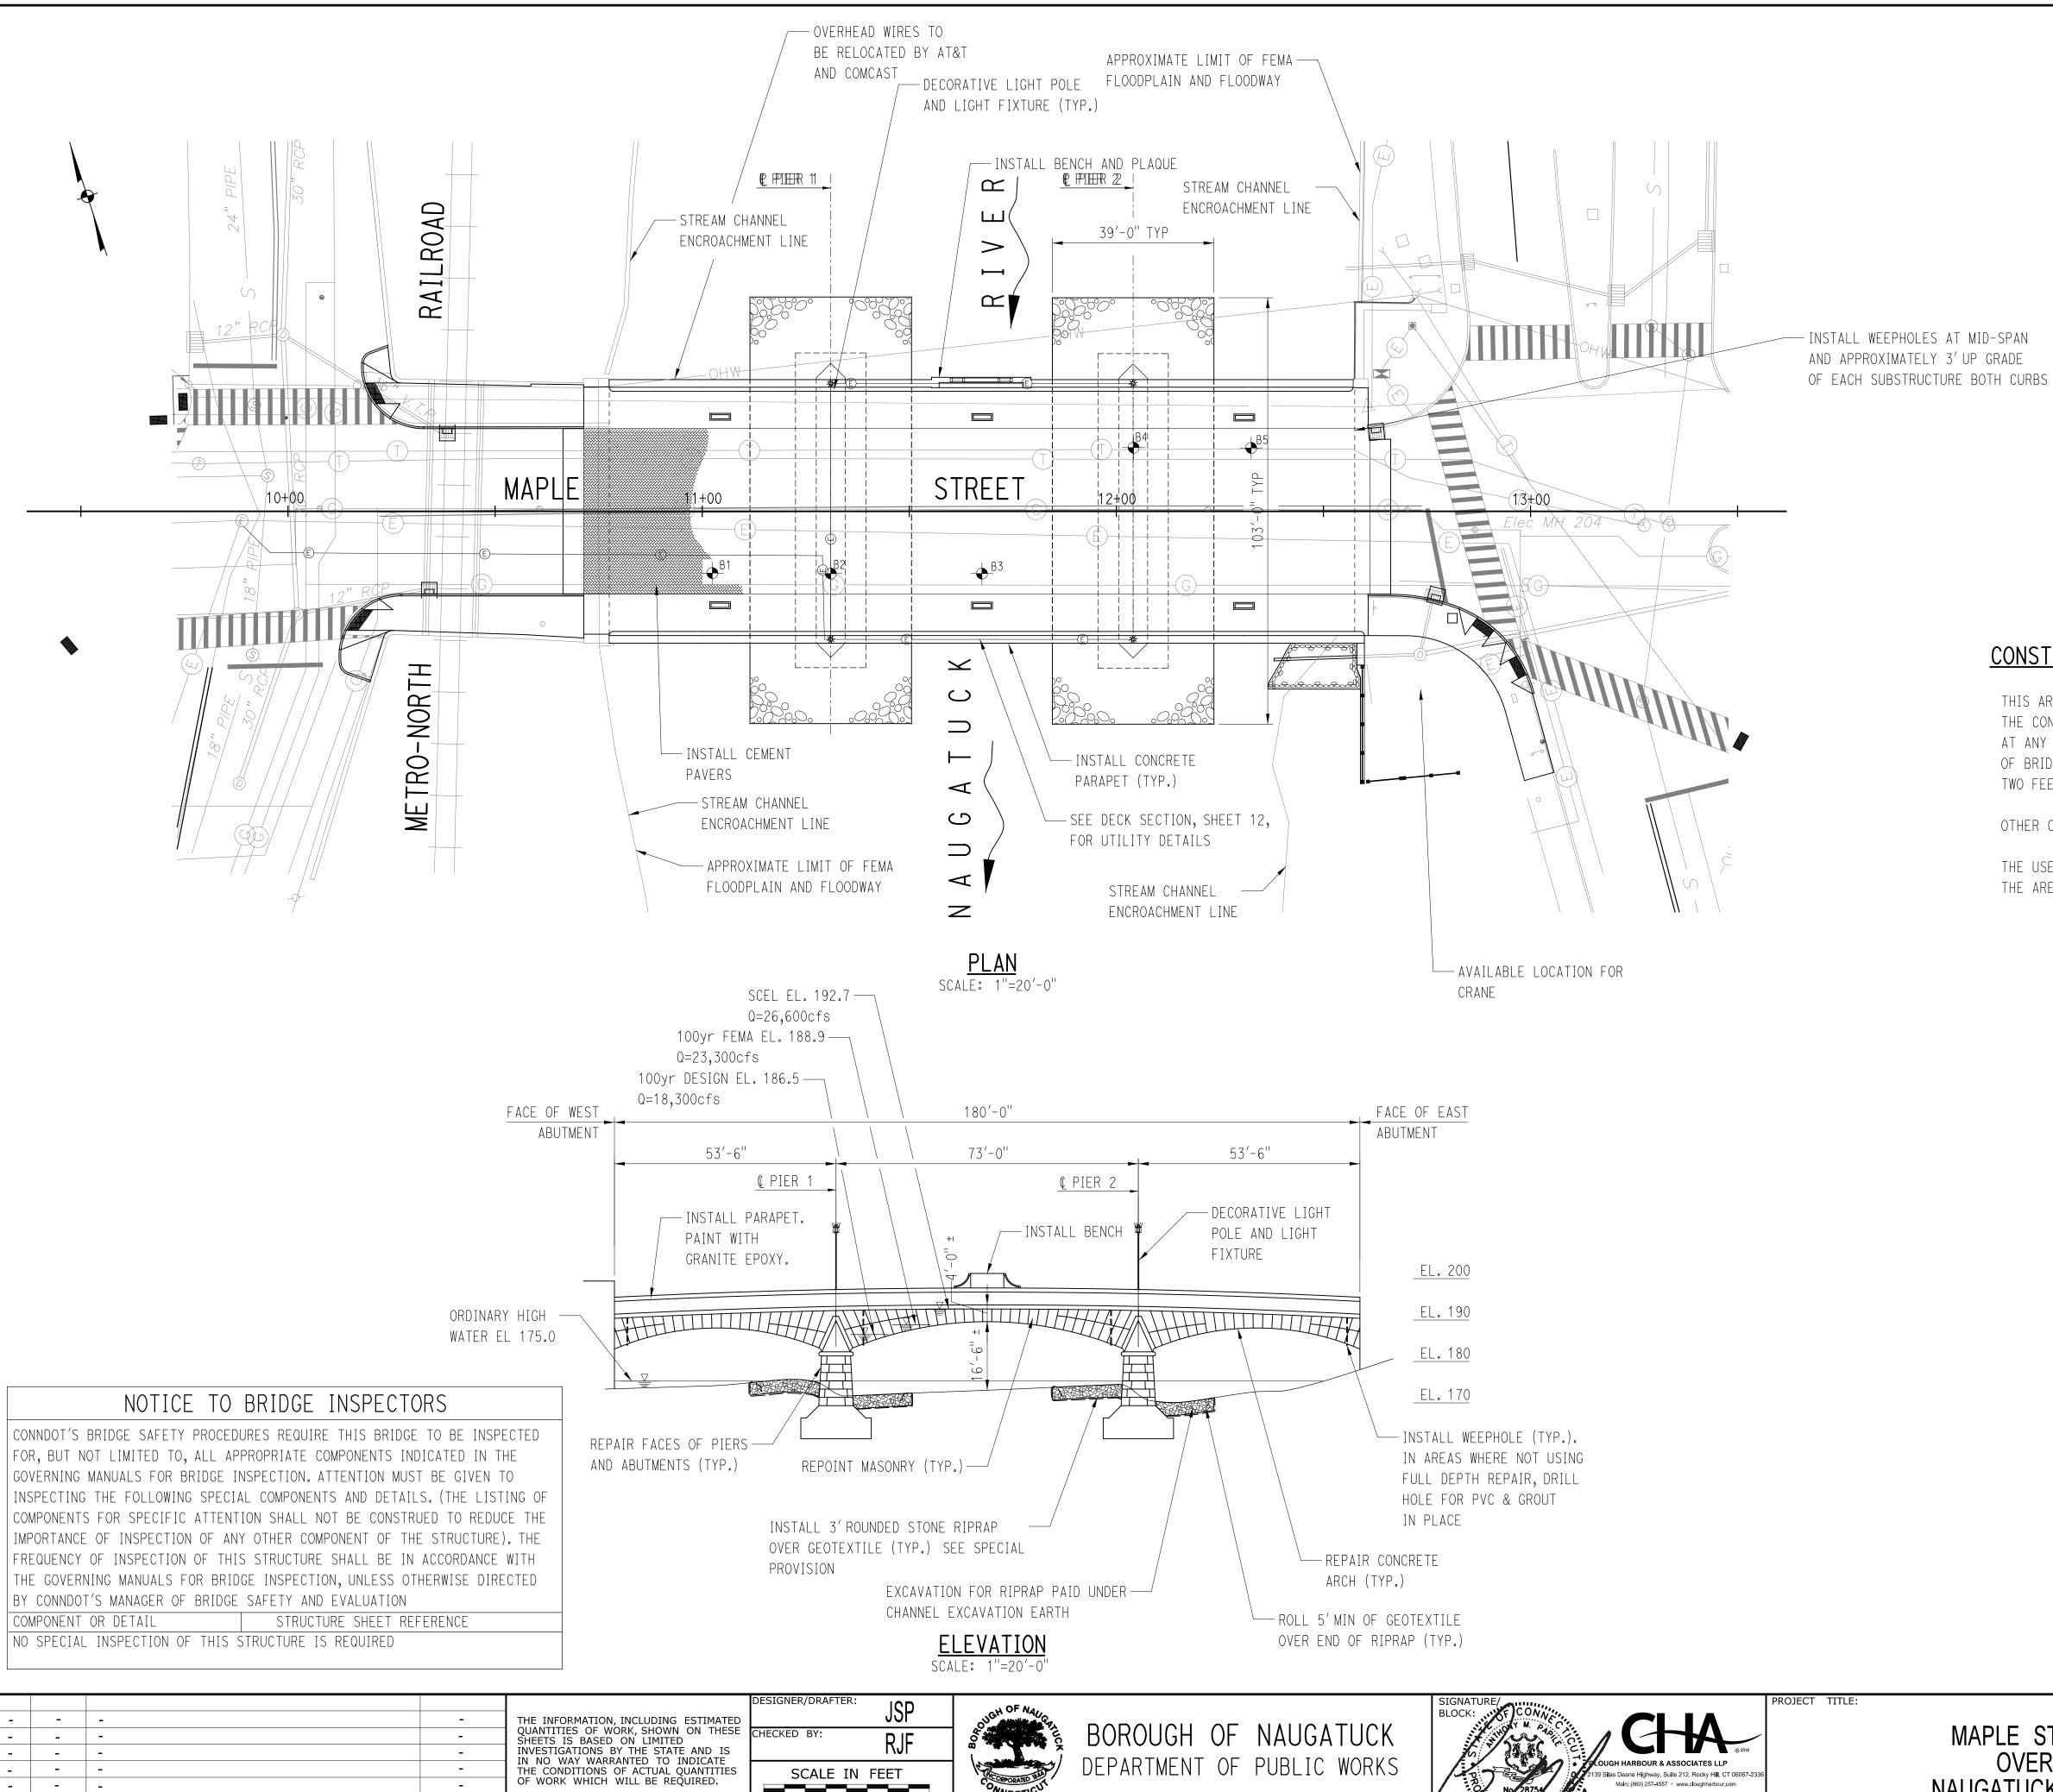

SCALE 1"=20'

Filename: V:\Projects\RCT\16319 Maple Street\CAD\Bridge\General Plan.dgn

REV. DATE

REVISION DESCRIPTION

SHEET NO. Plotted Date: 1/7/2016

GENERAL NOTES:

SPECIFICATIONS:

CONNECTICUT DEPARTMENT OF TRANSPORTATION FORM 816 (2004), SUPPLEMENTAL SPECIFICATIONS (2015), AND SPECIAL PROVISIONS.

DESIGN SPECIFICATIONS:

AASHTO LRFD BRIDGE DESIGN SPECIFICATIONS (AASHTO-2014), WITH INTERIMS, AS SUPPLEMENTED BY THE CONNECTICUT DEPARTMENT OF TRANSPORTATION BRIDGE DESIGN MANUAL (2003).

ALLOWABLE DESIGN STRESSES:

CLASS 'F' CONCRETE f'c = 4000 PSI
REINFORCEMENT (ASTM A615 GRADE 60) fy = 60,000 PSI

LIVE LOAD: HL93

DESIGN METHOD:
LOAD AND RESISTANCE FACTOR DESIGN METHOD FOR C.I.P. CONCRETE.

FUTURE PAVING ALLOWANCE:

NONE

DIMENSIONS:

WHEN ELEVATIONS OR DECIMAL DIMENSIONS ARE GIVEN TO LESS THAN THREE DECIMAL PLACES, THE OMITTED DIGITS SHALL BE ASSUMED TO BE ZEROS.

CONSTRUCTION NOTES:

THIS ARCH STRUCTURE MUST BE UN-LOADED AND LOADED UNIFORMLY ON BOTH SIDES OF ALL ARCHES.

THE CONCRETE FILL SHALL BE REMOVED FROM ALL ARCHES SO THAT THE DIFFERENTIAL ELEVATION OF FILL

AT ANY LOCATION DOES NOT EXCEED TWO FEET. CONCRETE FILL SHALL BE REPLACED OVER THE ENTIRE LENGTH

OF BRIDGE SUCH THAT THE DIFFERENTIAL ELEVATION OF CONCRETE FILL AT ANY LOCATION DOES NOT EXCEED

TWO FEET. NO HEAVY EQUIPMENT WILL BE ALLOWED ON THE UN-BACKFILLED ARCH.

OTHER CONDITIONS ON DEMOLITION AND REPAIR CAN BE FOUND IN THESE DRAWINGS.

THE USE OF CRANES AND CONCRETE PUMP TRUCKS WILL BE REQUIRED TO COMPLETE THE CONSTRUCTION.

THE AREA AT THE SOUTHEAST CORNER OF THE BRIDGE CAN BE USED FOR CRANES.

HYDRAULIC DATA				
DRAINAGE AREA	232	232 SQ. MI.		
DESIGN FREQUENCY	100	YEAR		
DESIGN DISCHARGE	18,30	OO CFS		
AVERAGE DAILY FLOW ELEVATION	176.0 FT	ESTIMATED		
DESIGN WATER SURFACE ELEVATION-UPSTREAM	186.5 FT			
DESIGN WATER SURFACE ELEVATION-DOWNSTREAM	185	185.6 FT		
MAXIMUM SCOUR ELEVATION	157	157.7 FT		
FREQUENCY	5	500		
DISCHARGE	25,500			
WORST CASE SCOUR SUB-STRUCTURE UNIT	Pier No	. 2 (EAST)		

CONCRETE D)ISTR	IBUTION
ITEM	UNIT	QUANTITY
SUPERSTRUCTURE	C.Y.	850
SUBSTRUCTURE	C.Y.	0
FOOTINGS	C.Y.	0
TOTAL	C.Y.	850

INSPECTION O	FFIE	LD WELDS
METHODS	UNIT	QUANTITY
ULTRASONIC	INCH	NONE
MAGNETIC PARTICLE	FEET	NONE

MAPLE STREET
OVER
NAUGATUCK RIVER

NAUGATUCK	9087-400
DRAWING TITLE:	DRAWING NO.
BRIDGE GENERAL PLAN	SHEET NO. 9 of 2

CLOUGH HARBOUR & ASSOCIATES LLP					TE S	51	BORING	NO. B1				
CLIEN	ECT & LO	ATUCK			T BRIDGE N	NAUGA	TUCK, CT				SHEET	OT NO.: 16319 NO.: 1 OF 1
CONT							0005				TON: 191.2 FT	
	GROU 	NDWATE		UREMENT PTH TO (F1		1		CASING	SAMPLER	CORE BARREL	START	DATE: 8/10/2007 DATE: 8/10/2007
DATE	Е ПМ	E V			BOTTOM OF BORING	TYPE:						27.1.2.
				O/ (OII TO	Bornito	SIZE I.	D.:	_	_	_	RIG TYF	PE:
						HAMME		_	_	_	DRILLEF	₹:
						HAMME	R FALL:	_	_	_	INSPEC [*]	TOR: BRIAN KARIS
EPTH	STRATA	CORE		VERY/							l	
IN EET	CHANGE AND	RUN NO.		Q D ~	NOTES				FIELD) CLASSIFIC.	ATION	
	DESCRIPTION O.10 ft		FT.	%						Pavement		
	0.60 ft								F	iller Concre		
	0.98 ft	S1	2.29	100					Pc	rous Concr	ete	
									Fine A	ggregate C	oncrete	
	2.85 ft							BOT		CK AT ELE		 188.35_FT
								ВОТ	TOWN OF BE	OK // LLL	***********	100.00 1 1
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20 -												
20 -												BORING NO.
20 -		HARDNE	SS		WEATHERIN	IG III	BEDDING	THICKNESS	FRA	CTURE SPAC	CING:	BORING NO. R Q D
20 - 25 -	FIELD RD - F	KNIFE CAN	'T SCRATC	н	FRESH	1G	MASSIVE	> 4	0" VERY WIL			R Q D
20 – 25 – V. HARD	FIELD RD - F	KNIFE CAN	'T SCRATC	н		1G			0" VERY WII 0" WIDE 2" MEDIUM	DE 8	CING: > 6' 2' - 6' "- 24" "2" - 8"	RQD

	CLOUGH HARBO	OUR & ASSOC	IATES LLP			TE (ST	CORIN	IG RE	PORT		BORING	NO. B2	
PROJ				MAP	LE STREE	ET BRIDGE 1	NAUGA	TUCK, CT			_	PROJEC	T NO.: 16319	
	T: NAU				DODING								NO.: 1 OF	
CONT					BORING SUREMEN							1	ION: 191.9 FT	
	GRO	JINU W	ATE		EPTH TO (F	т.)			CASING	SAMPLER	CORE BARREL	START	DATE: 8/10 DATE: 8/10	/2007 /2007
DATE	: П	ME	w	ATER	BOTTOM O CASING	F BOTTOM OF BORING	TYPE:						PE:	
							SIZE I.			_	_	-	₹:	
								R FALL:	_	_	_	INSPEC	tor: <u>Brian Ka</u>	RIS
DEPTH	STRATA		RE	REC	OVERY/									
IN FEET	CHANGE AND DESCRIPTION	N	O.	FT.	Q D	NOTES				FIELD) CLASSIFIC	ATION		
	0.13 ft			1 1+	%	-		\			Pavement			
	0.58 ft 0.60 ft							$\overline{}$			<u>Concrete F</u> . Waterprod			
										DIL	. waterprot	illiy		
	3.60 ft						-			Large /	Aggregate (oncrete		
_ 5 _ 5 10 ft S1 10 10					100					Smaller	Aggregate	Concrete	Э	
_	5.10 ft 5.39 ft					Possibly a	irch	\			laster Type			
						. 555.2.9								
- 10 —	10.6 ft									Small A	Aggregate (Concrete		
	11.0 ft						ŀ			С	ement Mor	tar		
-15 —	-	S	2	10	100									
	40.0.0									Larae /	Aggregate (Concrete		
	16.6 ft						ŀ				Plaster			
- 20 —						Discontinu	uitv.							
						possibly e	end							
						of footing								
						footing								
6.5		(:3	9.0	100									
- 25 —	1	3	J	9.0	100									
										Larae 4	Aggregate (Concrete		
	29.6 ft	-				+		ВОТТО	OM OF FOOT				BORING NO.	
			ראורי			\\/E \ TLIEDIA	10							
V. HAF		KNIFE	CAN'	T SCRAT		WEATHERIN FRESH	10	MASSIVE	THICKNESS	O" VERY WII	CTURE SPA De	CING: > 6' 2' - 6'	R Q > 90%	EXCELLENT
HARD	_	SCRA	TCHES	DIFFICU EASILY	LTLY	SLIGHT MODERATE		THICK MEDIUM	12" - 4 4" - 1	0" WIDE 2" MEDIUM	,	2' - 6' 3" - 24" '2" - 8"	90 - 75 75 - 50	GOOD FAIR

	CLOUGH HAR	BOUR & ASSOCI	IATES LLP	-	- OTD-5-	TES		BORING NO. B3							
CLIEN:	T: <u>NAU</u> RACTOF	GATU: : <u>NEV</u>	CK V En	GLAND	BORINGS		NAUG	ATUCK, CT				PROJECT NO.: 16319 SHEET NO.: 1 OF 1 ELEVATION: 192.5 FT			
DATE		UNDW Ime			SUREMENT EPTH TO (FT BOTTOM OF CASING		TYPE:		CASING	SAMPLER	CORE BARREL	START DATE: 2/27/2008 FINISH DATE: 2/27/2008 RIG TYPE:			
								.D.: ER WT.: ER FALL:	_ _ _	_ 	_ _ _	DRILLER:INSPECTOR: BRIAN KARIS			
DEPTH IN FEET	STRATA CHANGE AND DESCRIPTION	RU No		REC R FT.	OVERY/ Q D %	NOTES				FIELD	CLASSIFIC	CATION			
	0.10 ft 0.58 ft 0.96 ft S1 2.69 2.80 ft				100						Pavement Iler Concre rous Concr	ete			
									ВОТ		tural Slab CK AT ELE	(Arch) VATION 189.7 FT			
- 5 -															
— 10 —															
– 10 —															
-15 -	_														
20															
- 20 -															
– 25 –															
												BORING NO.			
V. HAR HARD	RD -		CAN'	SS T SCRAT DIFFICU	СН	WEATHERIN FRESH SLIGHT	IG	BEDDING MASSIVE THICK	THICKNESS: > 4	O" VERY WID	CTURE SPA				
MED. H SOFT V. SOF	HARD -		TCHES VES	EASILY	LILI	MODERATE HIGH COMPLETE		MEDIUM THIN	12 - 4 4" - 1: < ·	2" MEDIUM	2-1, DSE <	> 6' > 90% EXCELLEN' 2' - 6' 90 - 75 GOOD 3" - 24" 75 - 50 FAIR /2" - 8" 50 - 25 POOR < 2-1/2" < 25% VERY POO			

BORING NOTES:

- 1. BORINGS WERE MADE BY NEW ENGLAND BORING IN AUGUST 2007.
- 3. BORINGS ARE AVAILABLE AT THE TOWN HALL FOR REVIEW.

						DESIGNER/DRAFTER:	
					THE INFORMATION, INCLUDING ESTIMATED		
					QUANTITIES OF WORK, SHOWN ON THESE SHEETS IS BASED ON LIMITED	CHECKED BY:	
					INVESTIGATIONS BY THE STATE AND IS IN NO WAY WARRANTED TO INDICATE		
					THE CONDITIONS OF ACTUAL QUANTITIES OF WORK WHICH WILL BE REQUIRED.	SCALE IN	F
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							/ r
REV.	DATE	REVISION DESCRIPTION	SHEET	NO.	Plotted Date: 1/7/2016	SCALE: 1/	′4







MAPLE STREET	
OVER	
NAUGATUCK RIVER	

VN:		PROJECT NO.				
	NAUGATUCK	9087-4000				
		DRAWING NO.				
AWING TITLE:						
	BORING 1 OF 2	SHEET NO.				
	DOMING I OI Z	10 of 27				

	CLOUGH HARBOL	JR & ASSOCIATION	ON: MAP	 F STRFF	T BRIDGE N			IG RE			BORING NO. B4 PROJECT NO.: 16319
CLIEN'	T: <u>NAUG</u>	ATUC	K			171007111	010, 01				SHEET NO.: 1 OF 1
CONTE				BORINGS							ELEVATION: 191.9 FT
	GROU	INDWA		SUREMENT DEPTH TO (FI				CASING	SAMPLER	CORE BARREL	START DATE: 2/27/2008 FINISH DATE: 2/27/2008
DATE	TIM	/E	WATER	BOTTOM OF CASING	BOTTOM OF BORING	TYPE:					RIG TYPE:
						SIZE I.D.: HAMMER	NT.:	_	_	_	
						HAMMER		_	_	_	DRILLER: INSPECTOR: BRIAN KARIS
EPTH	STRATA	COR		OVERY/							
IN EET	CHANGE AND	RUN NO.		Q D %	NOTES				FIELD) CLASSIFIC	CATION
	DESCRIPTION 0.06 ft		F1+	/*		$\overline{}$					1
										Bit. Paveme	
	1.82 ft								Large A	Aggregate	Concrete
5 —	E 0.7 (:							Disc	continuous	Larae Aaa	regate Concrete
	5.23 ft	S1	10.0	100	Possibly A	rch				<u> </u>	,
					Reinforced						
					large Honeycom						
	0.07				voids	=			C. "	\ ~ ~ '	Conorata
	9.23 ft 9.25 ft					F			Plaste	Aggregate er Type Mo	terial
10 —	9.29 ft				Possibly Footing	\				orous Mate	
					rooting						
15 —		S2	10.0	100							
		32	10.0	100							
20 —											
									1	\ a a = = = = ± -	Canarata
	22.9 ft 22.92 ft				D " - 0	\			Large A	Aggregate aster Mate	concrete Prial
					Possibly S Footing	ub-					
25 —		S3	9.50	100							
					Discontinu	uity					
	29.5 ft						BOTTOM	OF FOOTIN		Aggregate ATION 162	
	FIELD	∟—— HARD	NESS		WEATHERIN	G		THICKNESS:		CTURE SPA	411
								> 4			
V. HAR HARD			CAN'T SCRAT CHES DIFFICU		FRESH SLIGHT		SSIVE ICK	12" - 4	O" VERY WIE O" WIDE	DE	> 6' > 90% EXCELLENT 2' - 6' 90 - 75 GOOD 8" - 24" 75 - 50 FAIR

		CATIO	N: <u>MA</u> F	LE STREE	ET BRIDGE I	NAUG	ATUCK, CT			_	PROJEC	CT NO.: 16319)
	T: <u>NAUG</u>) BORING	 S							NO.: <u> </u>	
JOINT				SUREMEN						CORF		DATE: $\frac{2/2}{\sqrt{2}}$	
				DEPTH TO (F	·T.)			CASING	SAMPLER	CORE BARREL	FINISH	DATE: $\frac{2/2}{2}$	7/2008
DATE	TIM	E	WATER	CASING	F BOTTOM OF BORING	TYPE:			_			PE:	
						SIZE I	.D.: ER WT.:	_	_	_		R:	
						НАММ	ER FALL:	_	_	_	INSPEC	TOR: BRIAN K	ARIS
DEPTH	STRATA	CORE	REC	L COVERY/									
IN FEET	CHANGE AND DESCRIPTION	RUN NO.	FT.	RQD'	NOTES	5			FIEL	D CLASSIFIC	CATION		
	0.13 ft				5	• •				Pavement			
	0.55 ft 0.92 ft	S1	2.29	100	Discontinu	iity	H/		ſ	Filler Concr			
		٥.							P	orous Conc	rete		
	2.42 ft			+	Rebar			R∩T		Aggregate ORE AT ELE			
					encounte	red		231				. =	
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- 15 —													
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	FIELD I				WEATHERIN	١G		THICKNESS		CTURE SPA		RC	
V. HAF HARD	- 9	SCRATC	AN'T SCRA' HES DIFFICU	JLTLY	FRESH SLIGHT		MASSIVE THICK	> 4 12" - 4 4" - 1	O" VERY W O" WIDE	IDE	> 6' 2' - 6' 8" - 24"	> 90% 90 - 75	EXCELLENT GOOD
			HES EASILY		MODERATE		MEDIUM	A" 1	2" MEDIUM		8" _ 24"	75 - 50 50 - 25	FAIR

NOTES:

1. FOR BORING NOTES, SEE SHEET 10.

REVISION DESCRIPTION

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0 4 8

SHEET NO. Plotted Date: 1/7/2016




SCALE: $\frac{1}{4}$ "=1'-0"


BOROUGH OF NAUGATUCK DEPARTMENT OF PUBLIC WORKS





MAPLE STREET OVER NAUGATUCK RIVER

WN:		PROJECT NO.				
	NAUGATUCK	9087-4000				
		DRAWING NO.				
AWING TITLE:						
	BORING 2 OF 2	SHEET NO.				
	DOMING 2 OF 2	11 of 27				

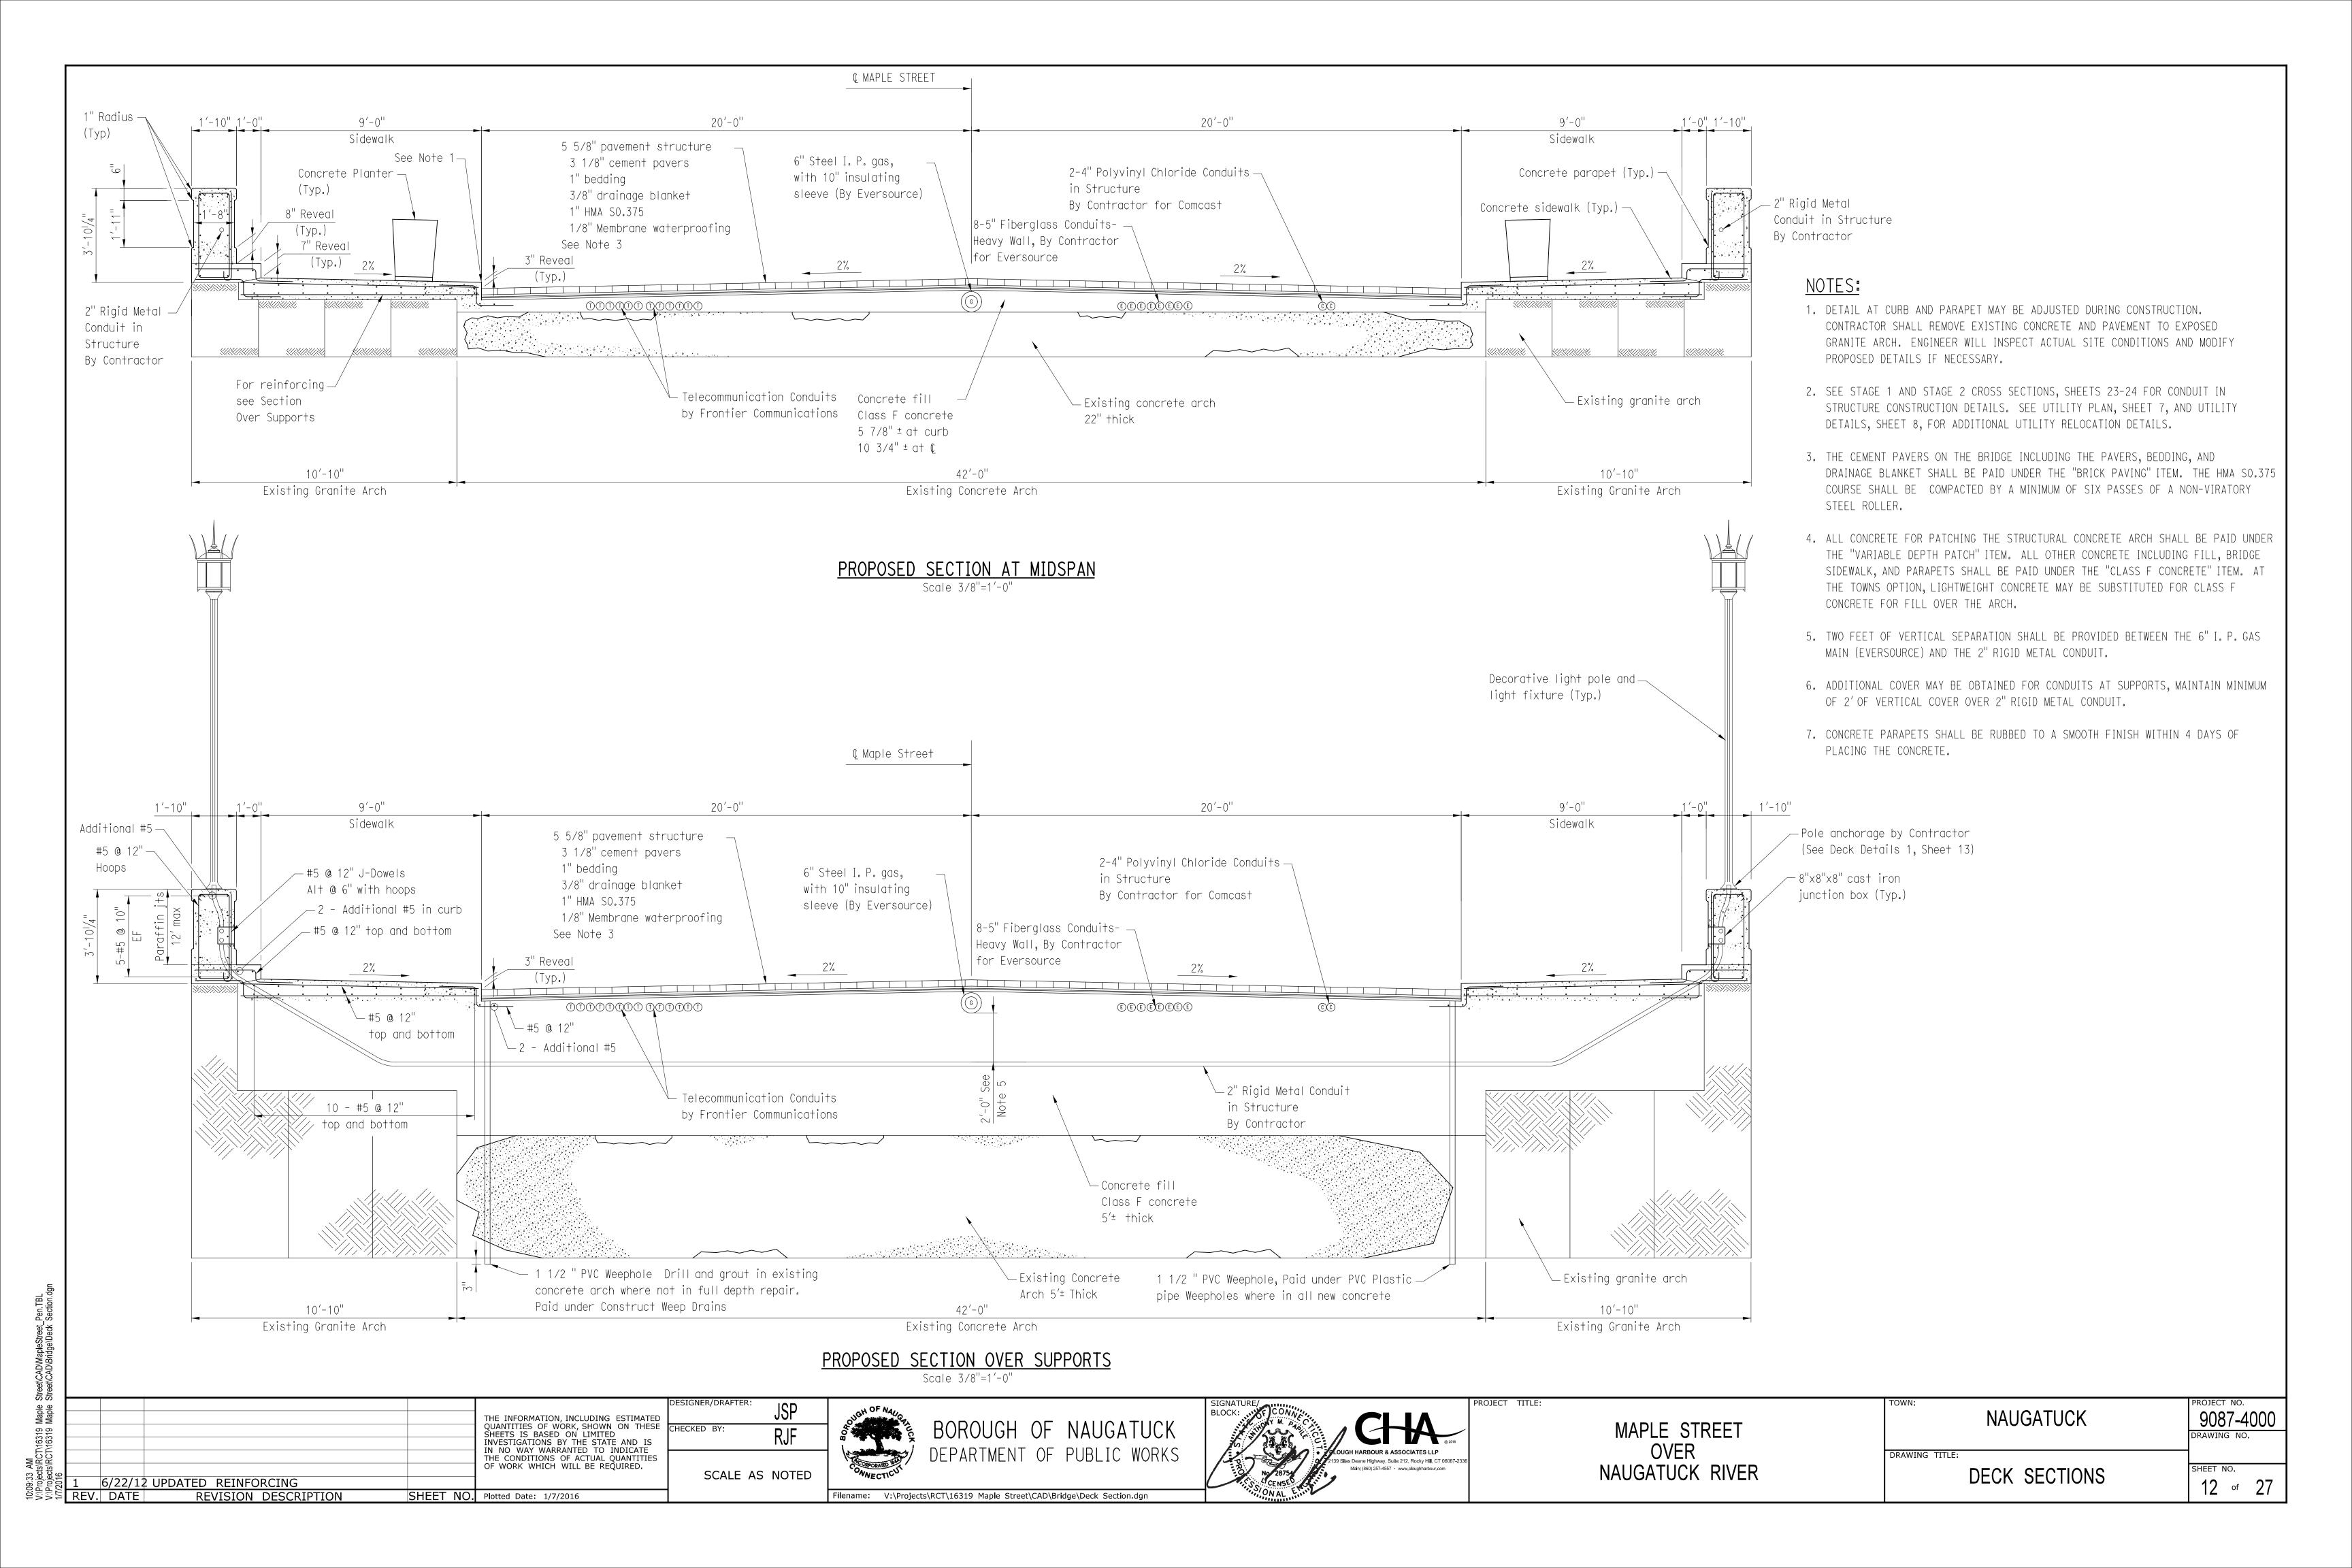

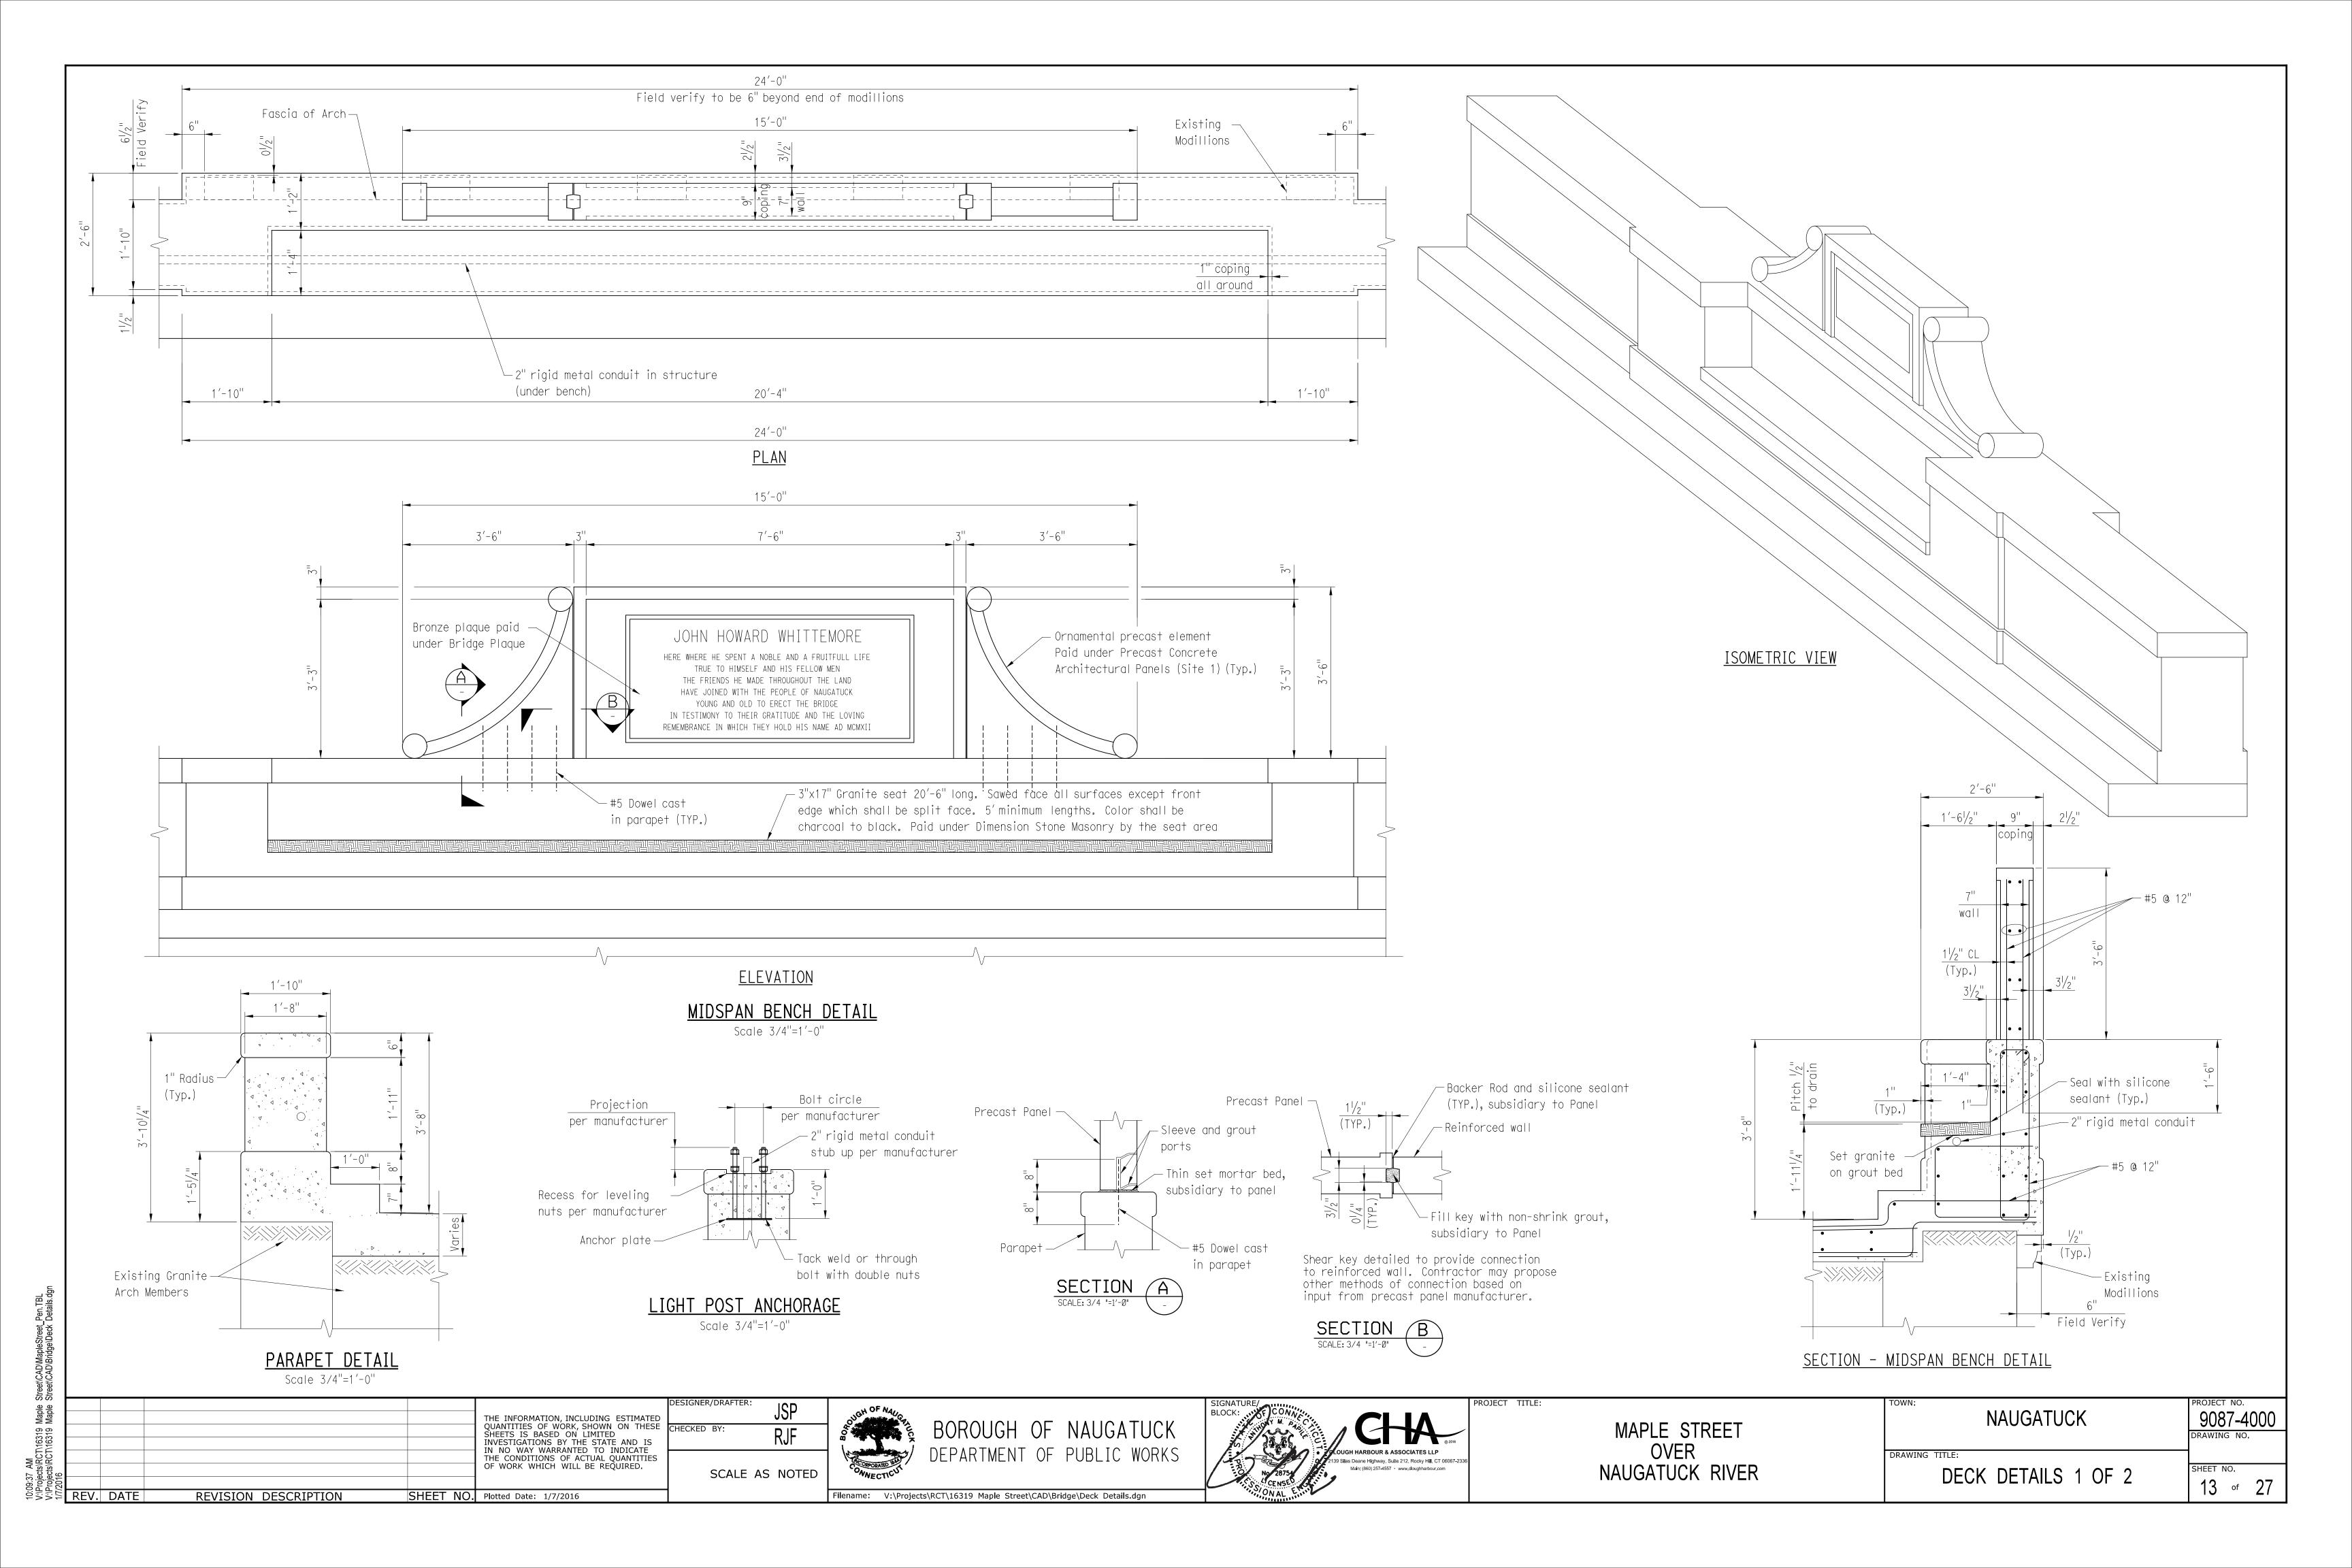


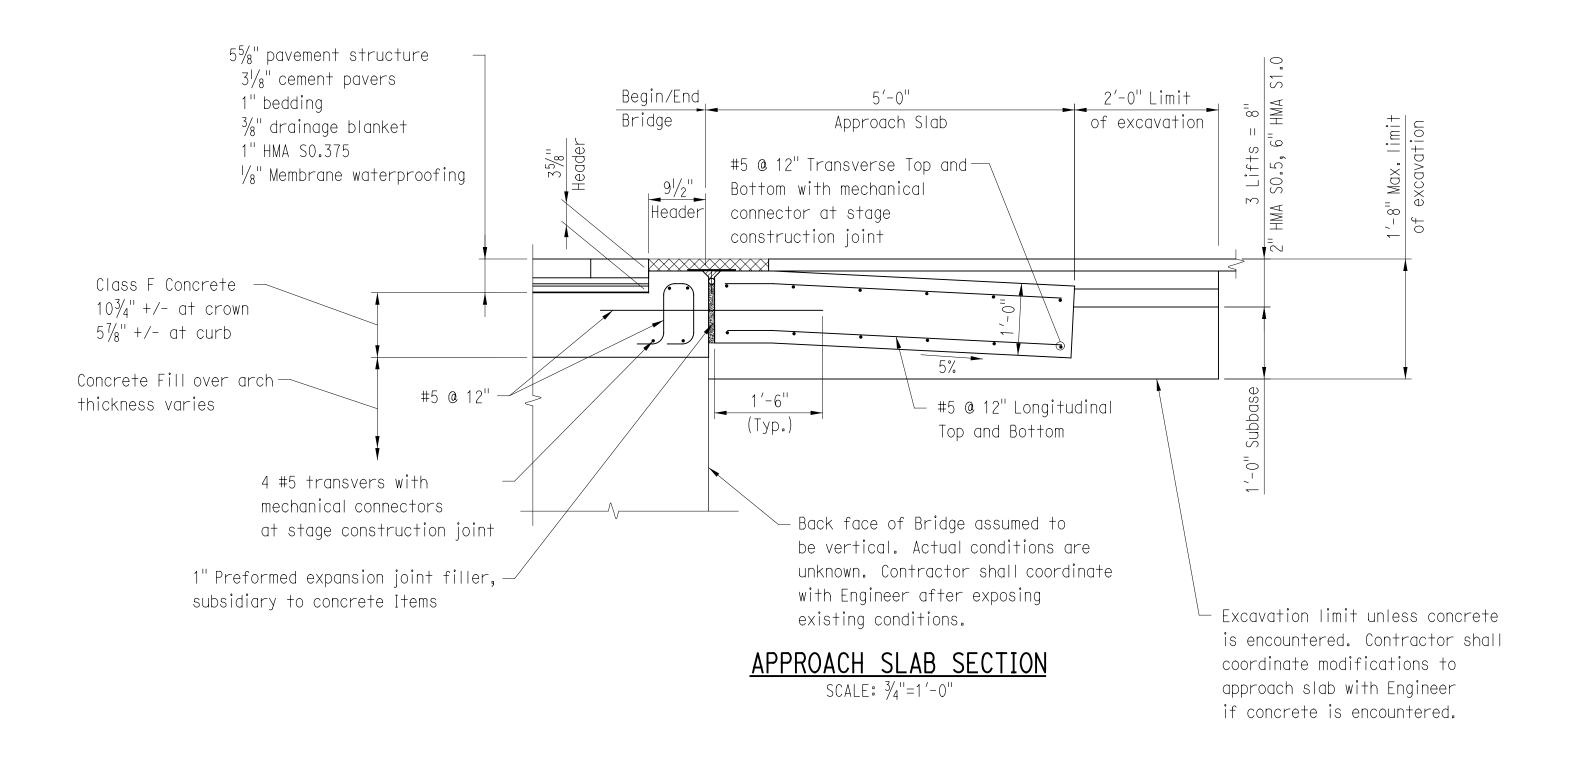


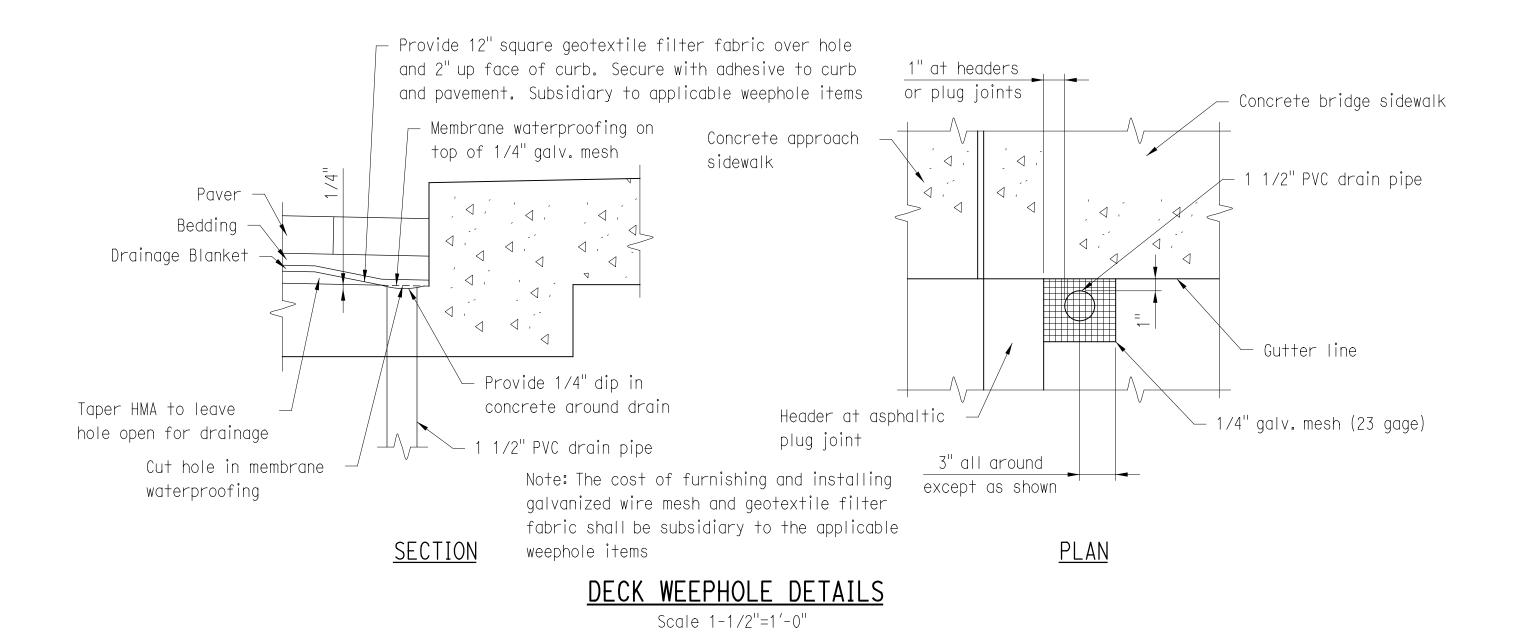

ASPHALTIC PLUG JOINT NOTES:

- 1. Cement pavers shall be placed prior to placing approach pavement. Approach pavement shall be placed up to cement pavers.
- 2. After approach pavement is placed, saw cut pavement 2" deep, 20" from edge of pavers. Remove pavement between saw cut and pavers. Install the asphaltic plug expansion joint system.
- 3. All costs for cutting and removing pavement, installing backer rod, silicone sealant, bridging plate, centering pin and asphaltic plug shall be included in the Asphaltic Plug Expansion Joint System.

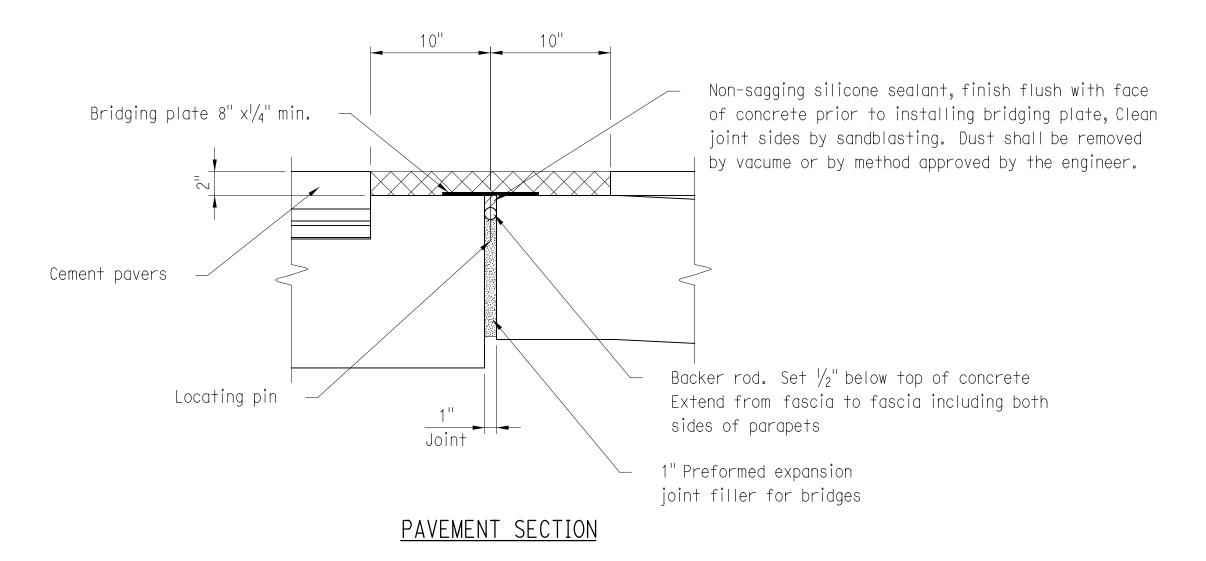

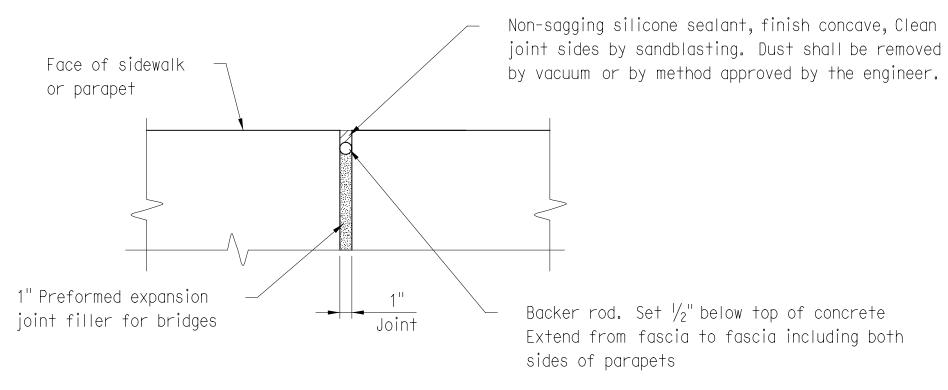

PARAPET/SIDEWALK SECTION

ASPHALTIC PLUG JOINT DETAILS SCALE: $1\frac{1}{2}^{11}=1^{2}-0^{11}$

6/22/12 CLARIFIED PAY ITEM REV. DATE

REVISION DESCRIPTION

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SHEET NO. Plotted Date: 1/7/2016

RJF SCALE AS NOTED

BOROUGH OF NAUGATUCK DEPARTMENT OF PUBLIC WORKS

Filename: V:\Projects\RCT\16319 Maple Street\CAD\Bridge\Deck Details 2 .dgn

39 Silas Deane Highway, Suite 212, Rocky Hill, CT 06067-23 Main: (860) 257-4557 · www.cloughharbour.com


MAPLE STREET **OVER** NAUGATUCK RIVER


NAUGATUCK DRAWING TITLE:

DECK DETAILS 2 OF 2

14 of 27

9087-4000

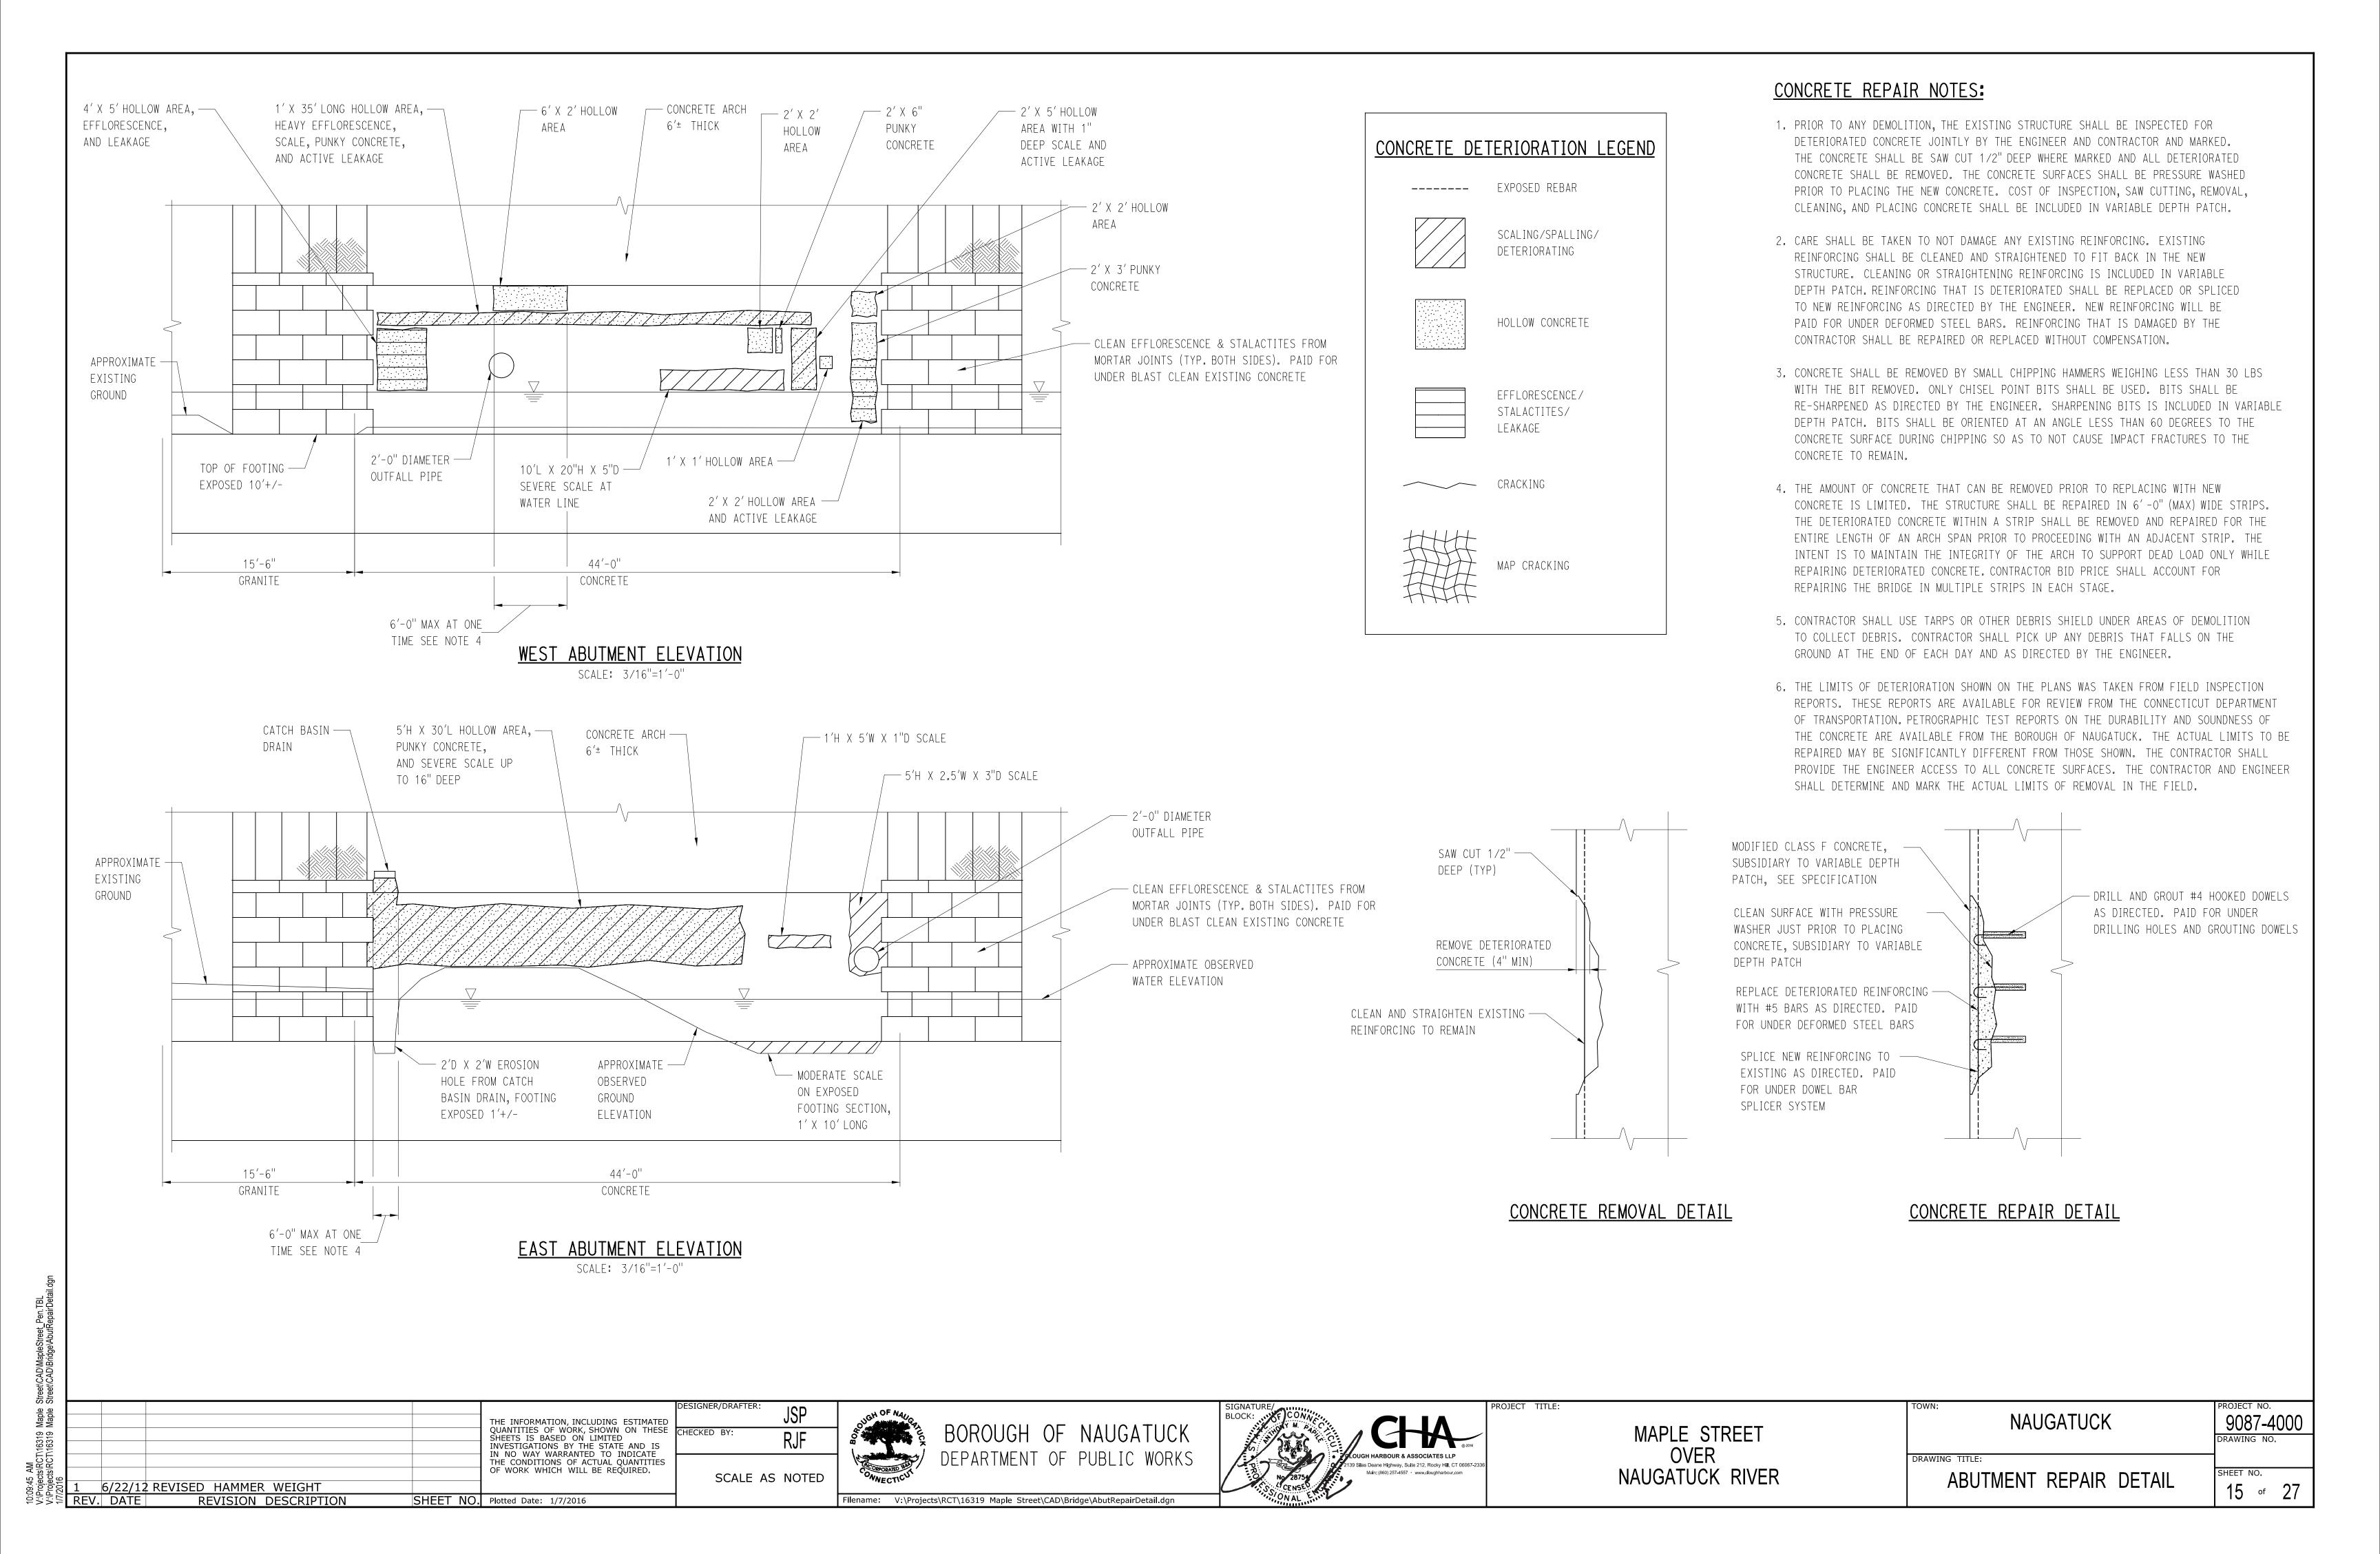

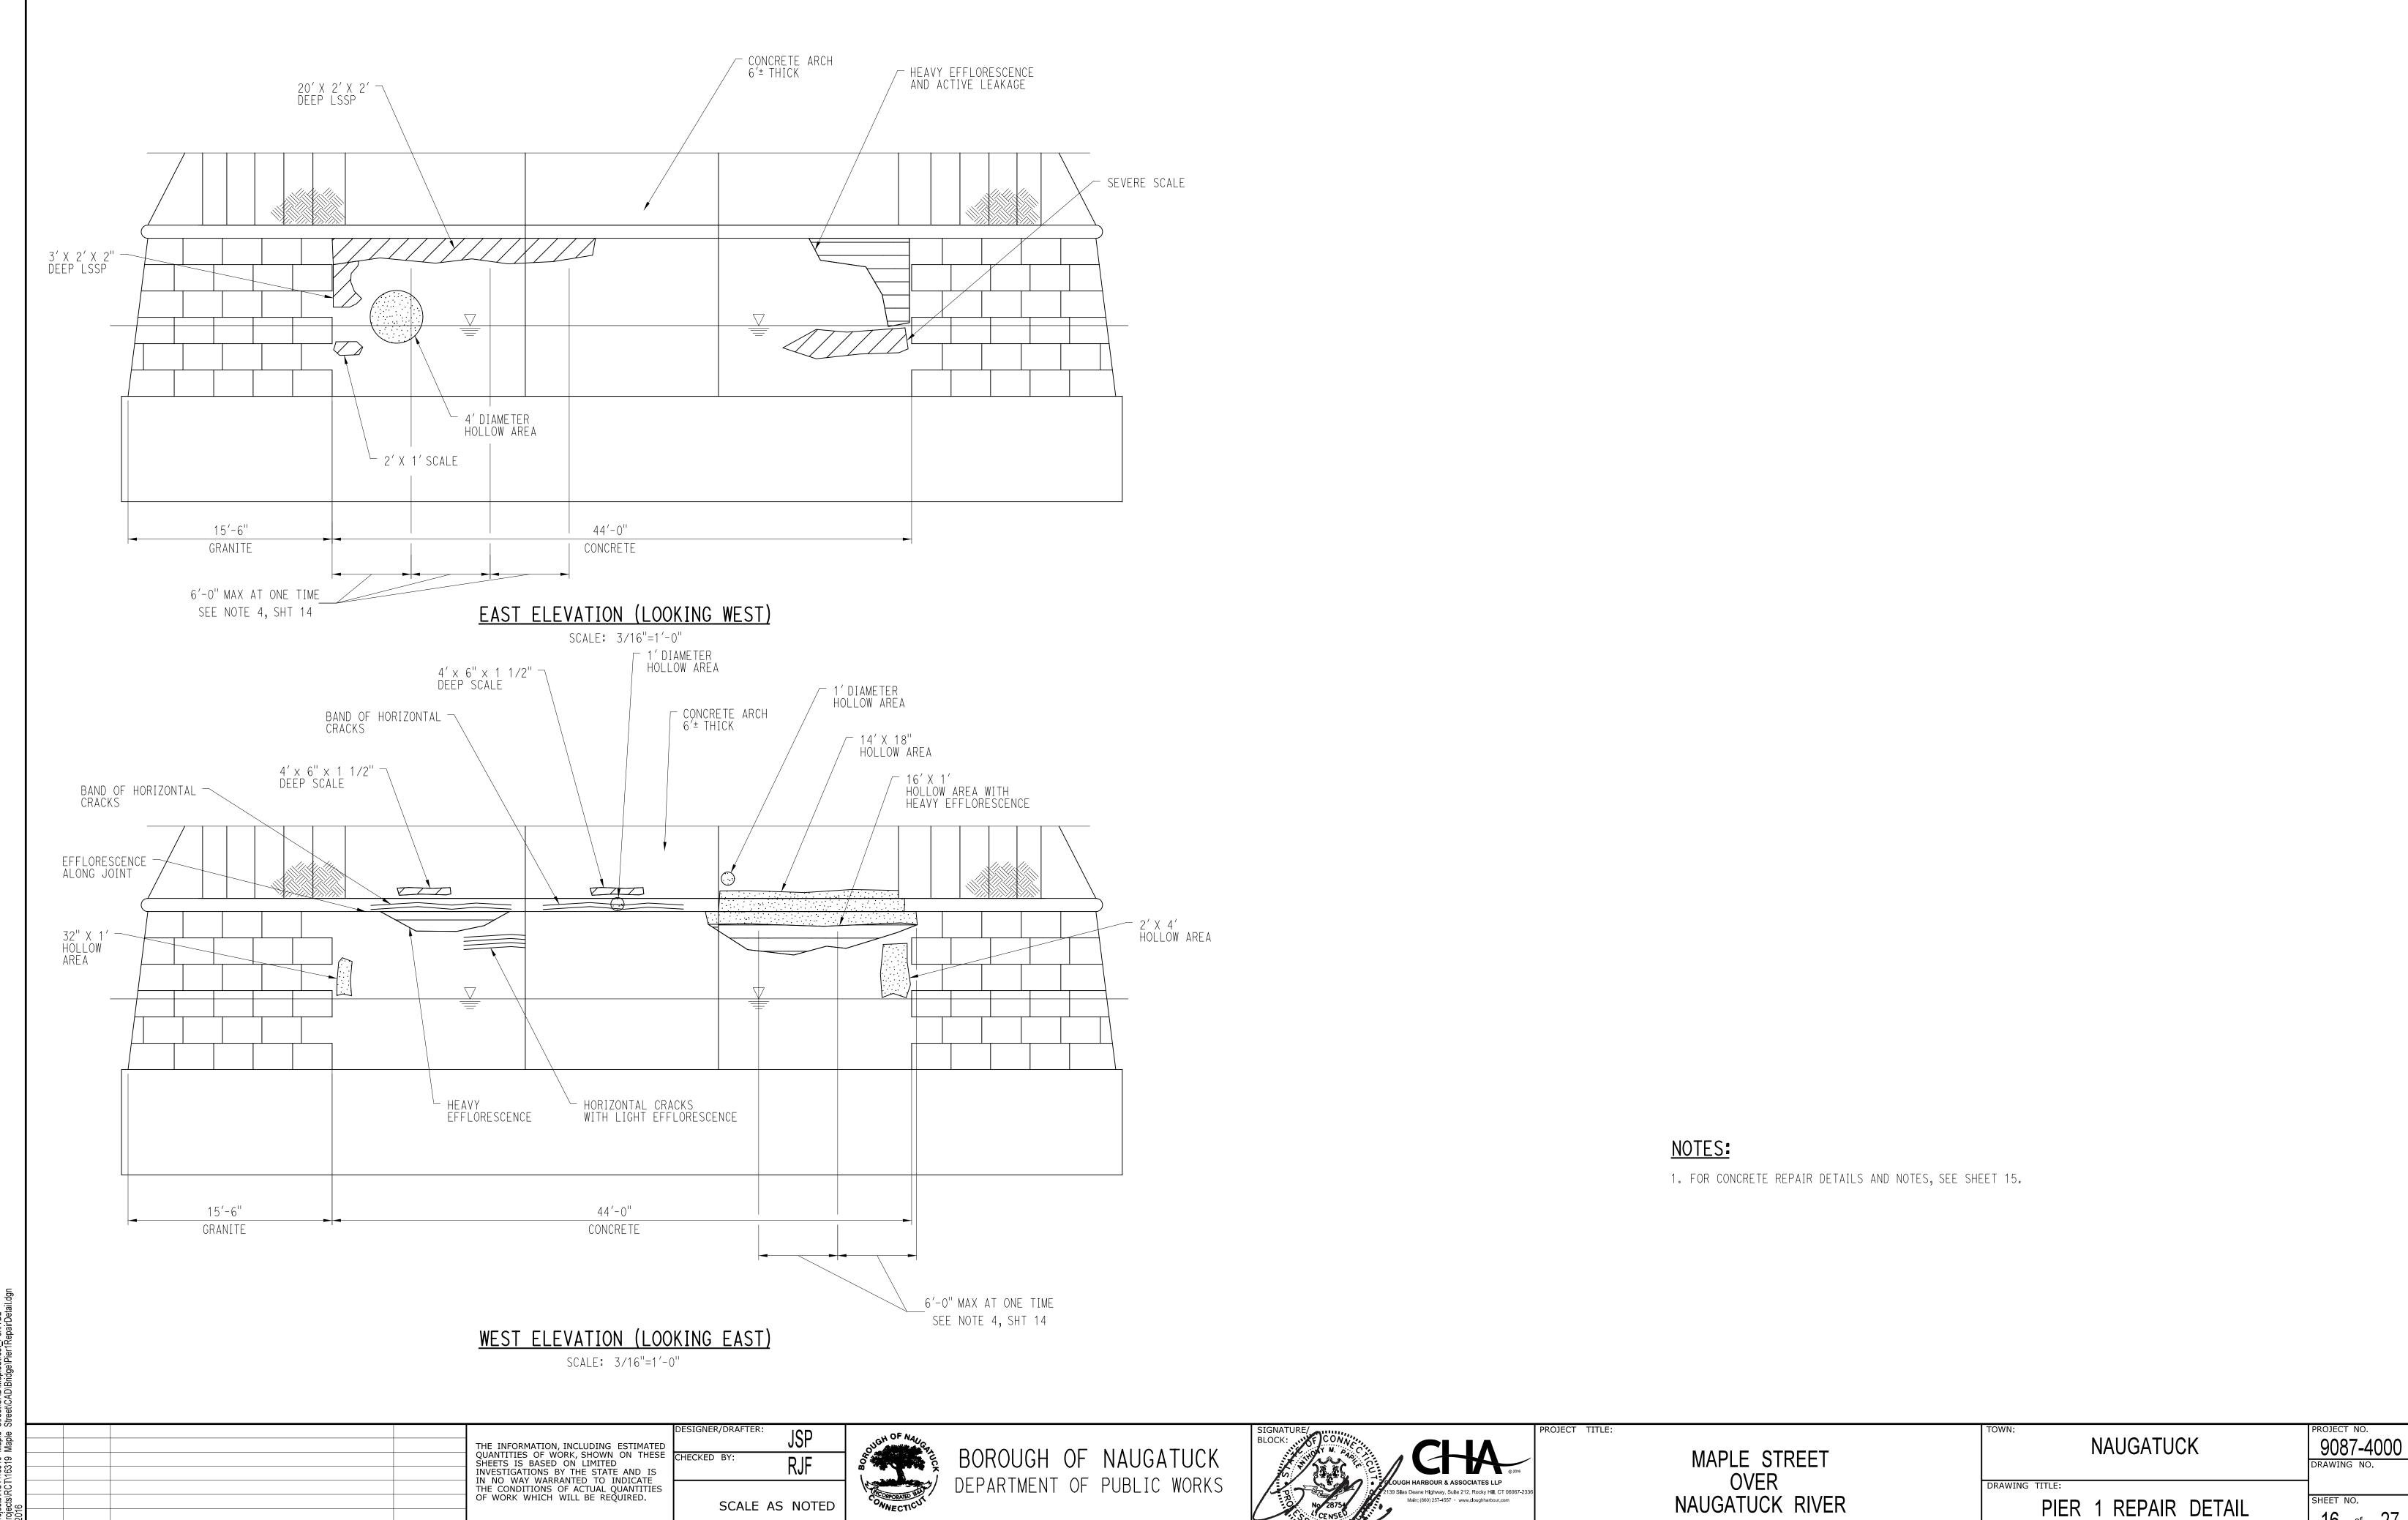

16 of 27


SCALE AS NOTED

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PSSE REV DATE

REVISION DESCRIPTION

SHEET NO. Plotted Date: 1/7/2016

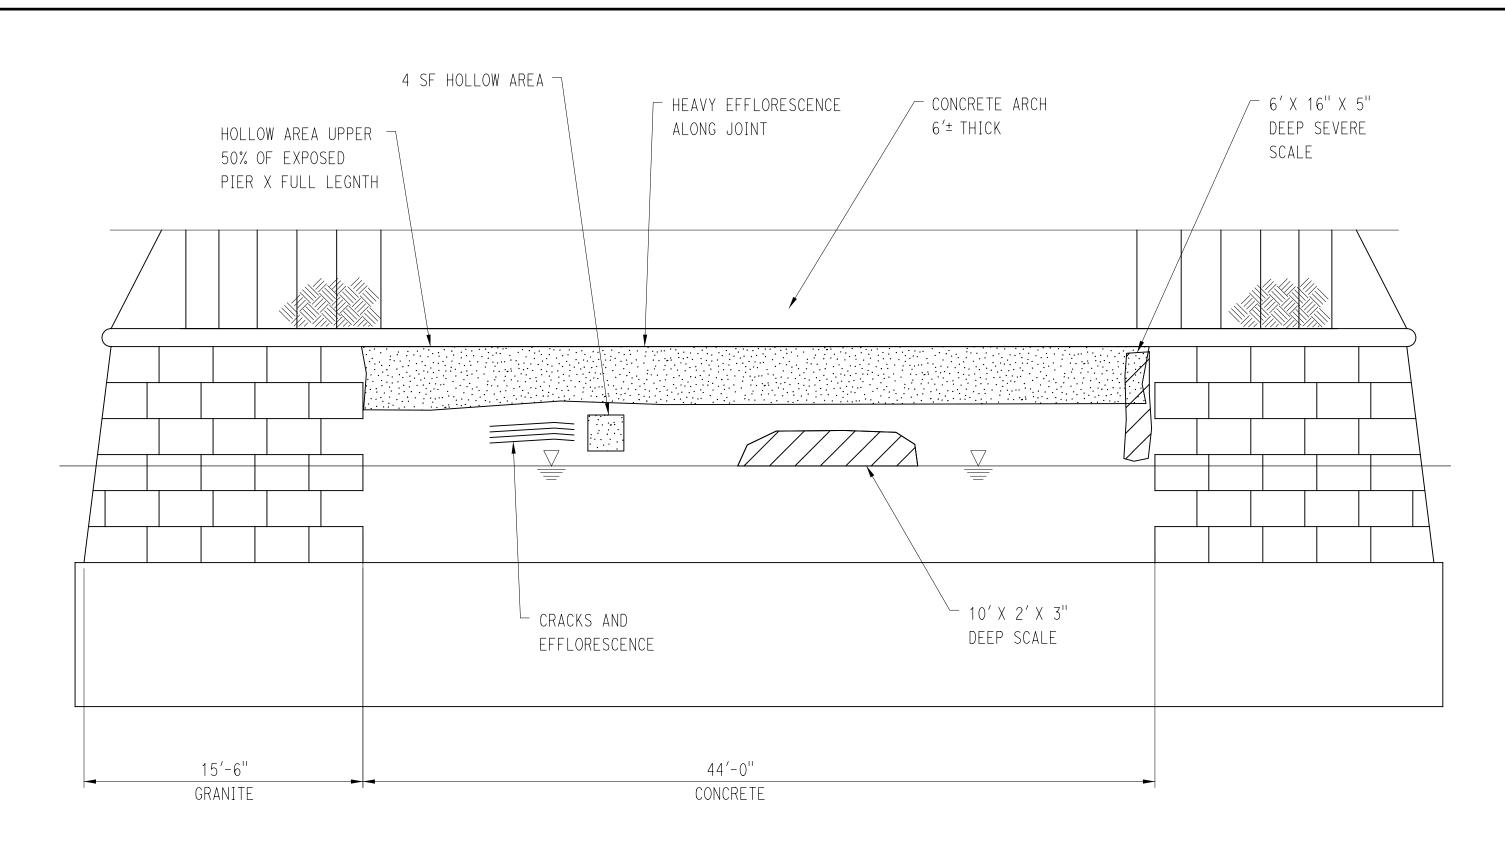

EAST ELEVATION (LOOKING WEST) SCALE: 3/16"=1'-0"

HOLLOW AREA LOWER 7 _ 2' X 2' X 2" _ 1' X 3' X 3" / 4′ X 8" X 12" CONCRETE ARCH DEEP LSSP DEEP LSSP 50% OF EXPOSED DEEP SCALE 6'± THICK 6′ X 3′ X 7" ─ PIER X FULL LENTH DEEP SCALE / JOINT OPEN UP TO 2" - 4'DIAMETER X 2" DEEP PUNKY CONCRETE - 8′ X 2′ SCALE ALONG WATER LINE 15'-6" 44'-0" GRANITE CONCRETE 6'-0" MAX AT ONE TIME WEST ELEVATION (LOOKING EAST) SEE NOTE 4, SHT 14


NOTES:

1. FOR CONCRETE REPAIR DETAILS AND NOTES, SEE SHEET 15.

တတ						
Maple Maple						THE INFORMATION, INCLU
52 AM ects/RCT\16319 ects/RCT\16319 16						QUANTITIES OF WORK, SH SHEETS IS BASED ON LII INVESTIGATIONS BY THE IN NO WAY WARRANTED
52 AM jects\RC jects\RC						THE CONDITIONS OF ACTUOES OF WORK WHICH WILL BE
10:09:52 V:\Projec V:\Projec 1/7/2016	REV.	DATE	REVISION DESCRIPTION	SHEET	NO.	Plotted Date: 1/7/2016

THE INFORMATION, INCLUDING ESTIMATED QUANTITIES OF WORK, SHOWN ON THESE SHEETS IS BASED ON LIMITED INVESTIGATIONS BY THE STATE AND IS IN NO WAY WARRANTED TO INDICATE THE CONDITIONS OF ACTUAL QUANTITIES OF WORK WHICH WILL BE REQUIRED.

SCALE: 3/16"=1'-0"

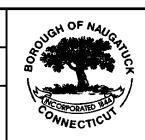

SCALE AS NOTED

BOROUGH OF NAUGATUCK DEPARTMENT OF PUBLIC WORKS

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COUGH HARBOUR & ASSOCIATES LLP


2139 Silas Deane Highway, Suite 212, Rocky Hill, CT 06067-2336


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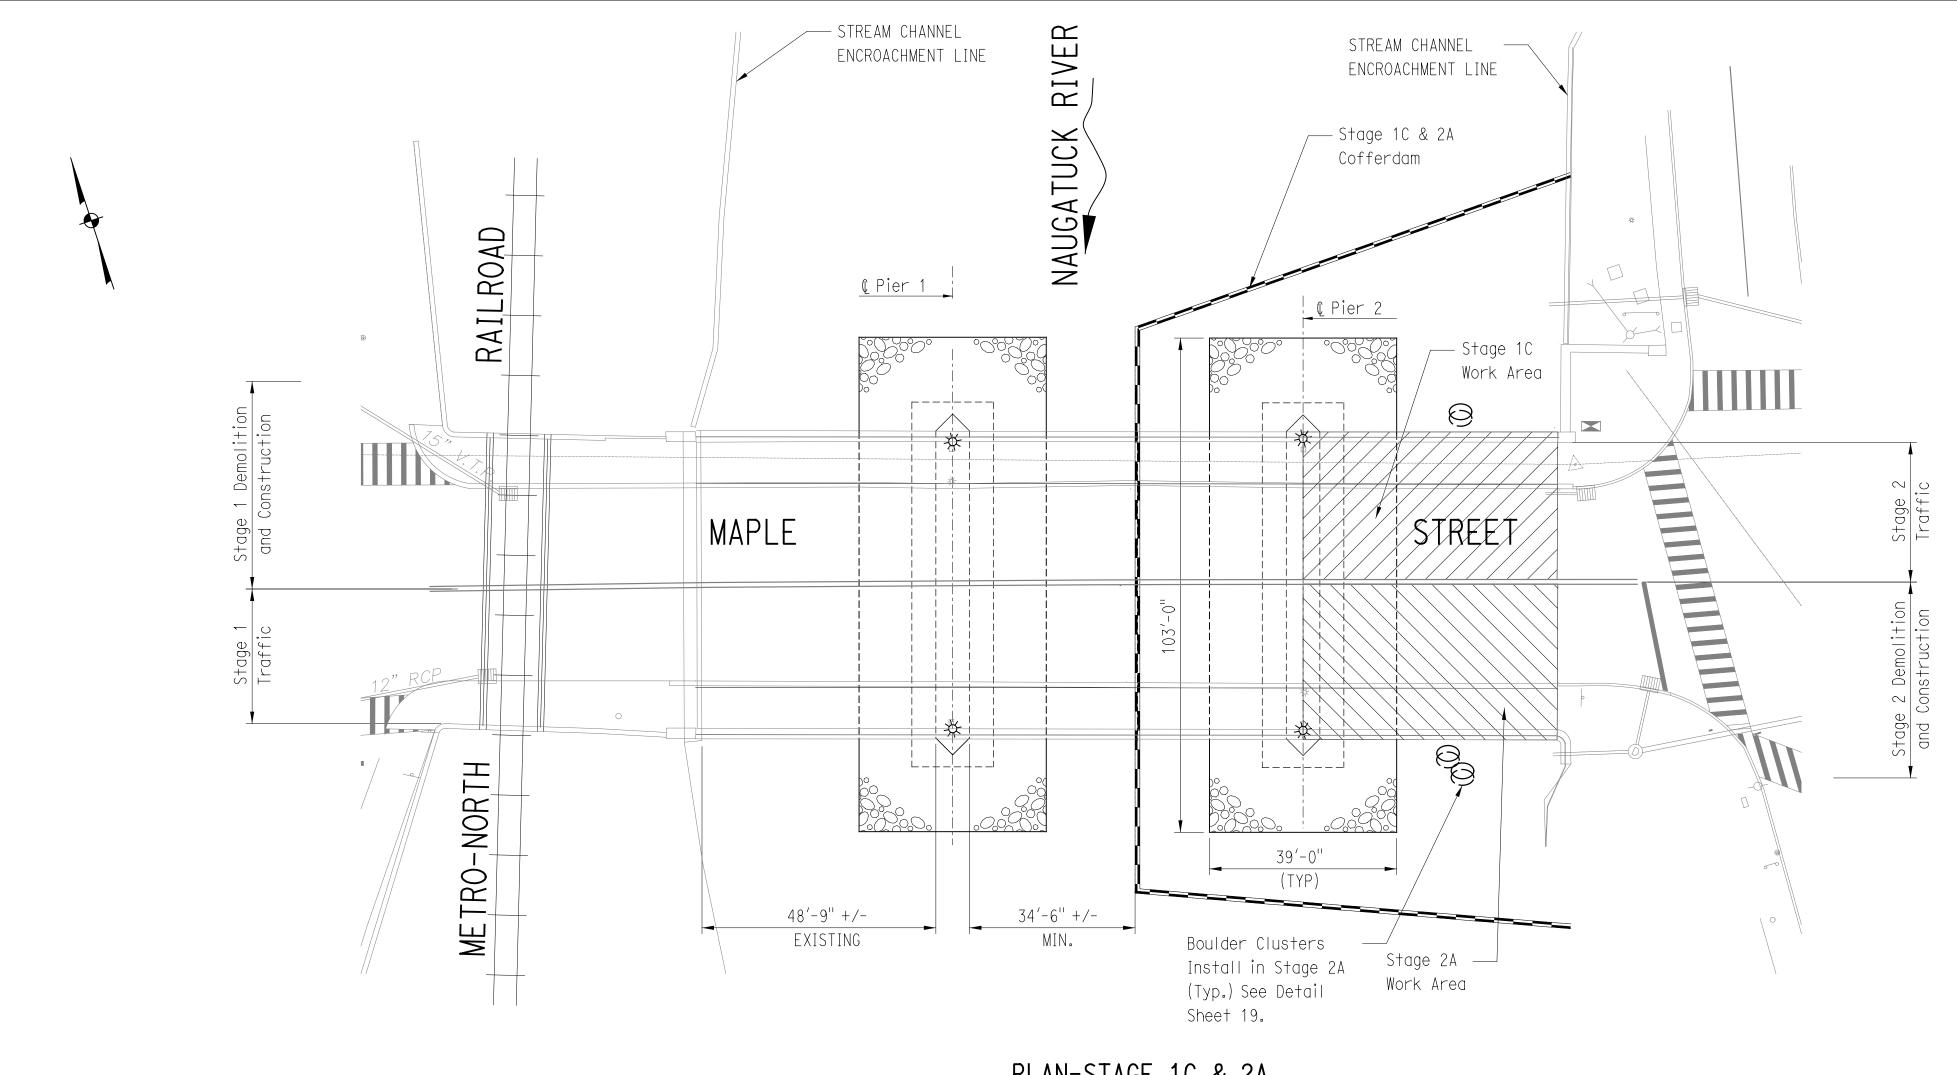
MAPLE STREET OVER NAUGATUCK RIVER

/N:	. —	PROJECT NO.			
NAUG <i>i</i>	9087-4000				
		DRAWING NO.			
WING TITLE:					
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FILIN Z INLF	AIN DETAIL	17 of	27		

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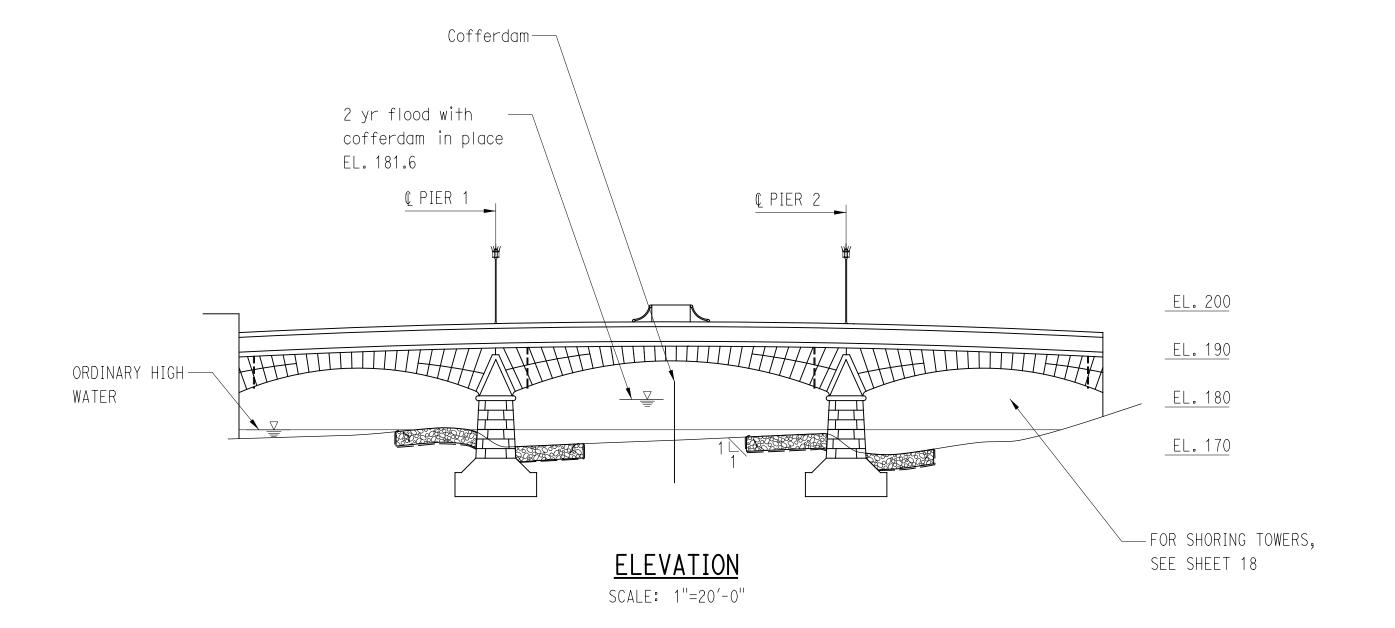




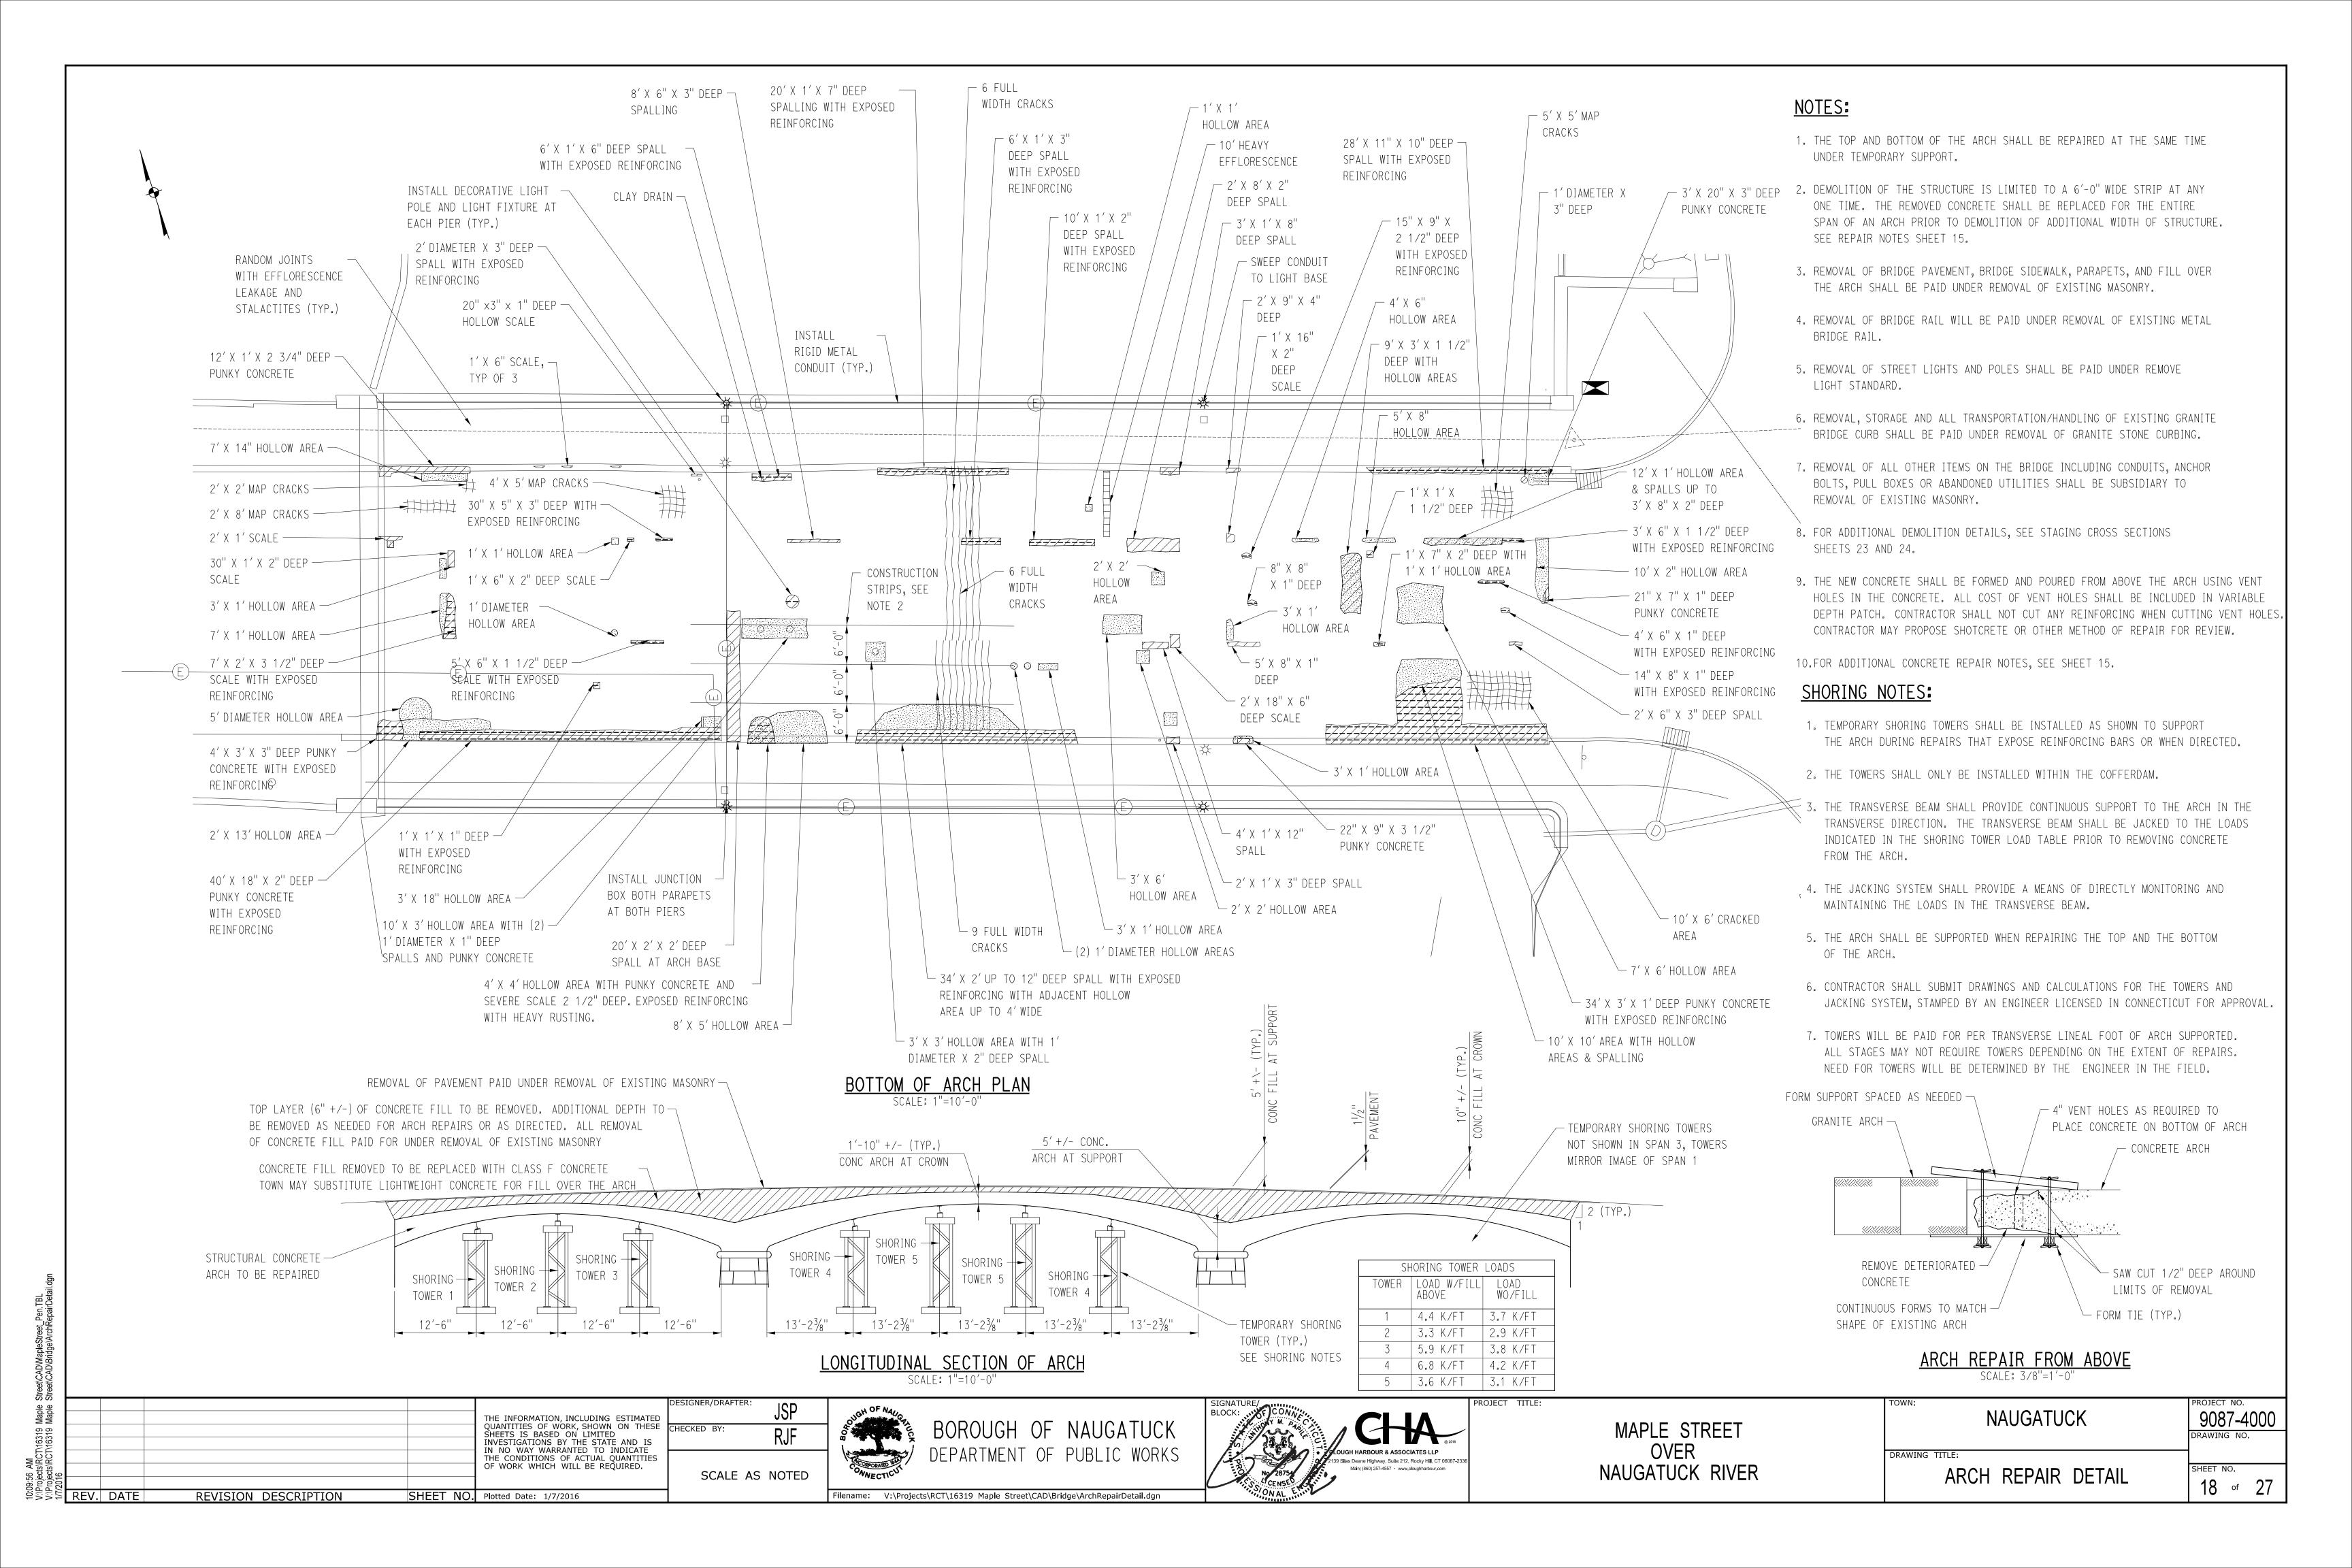

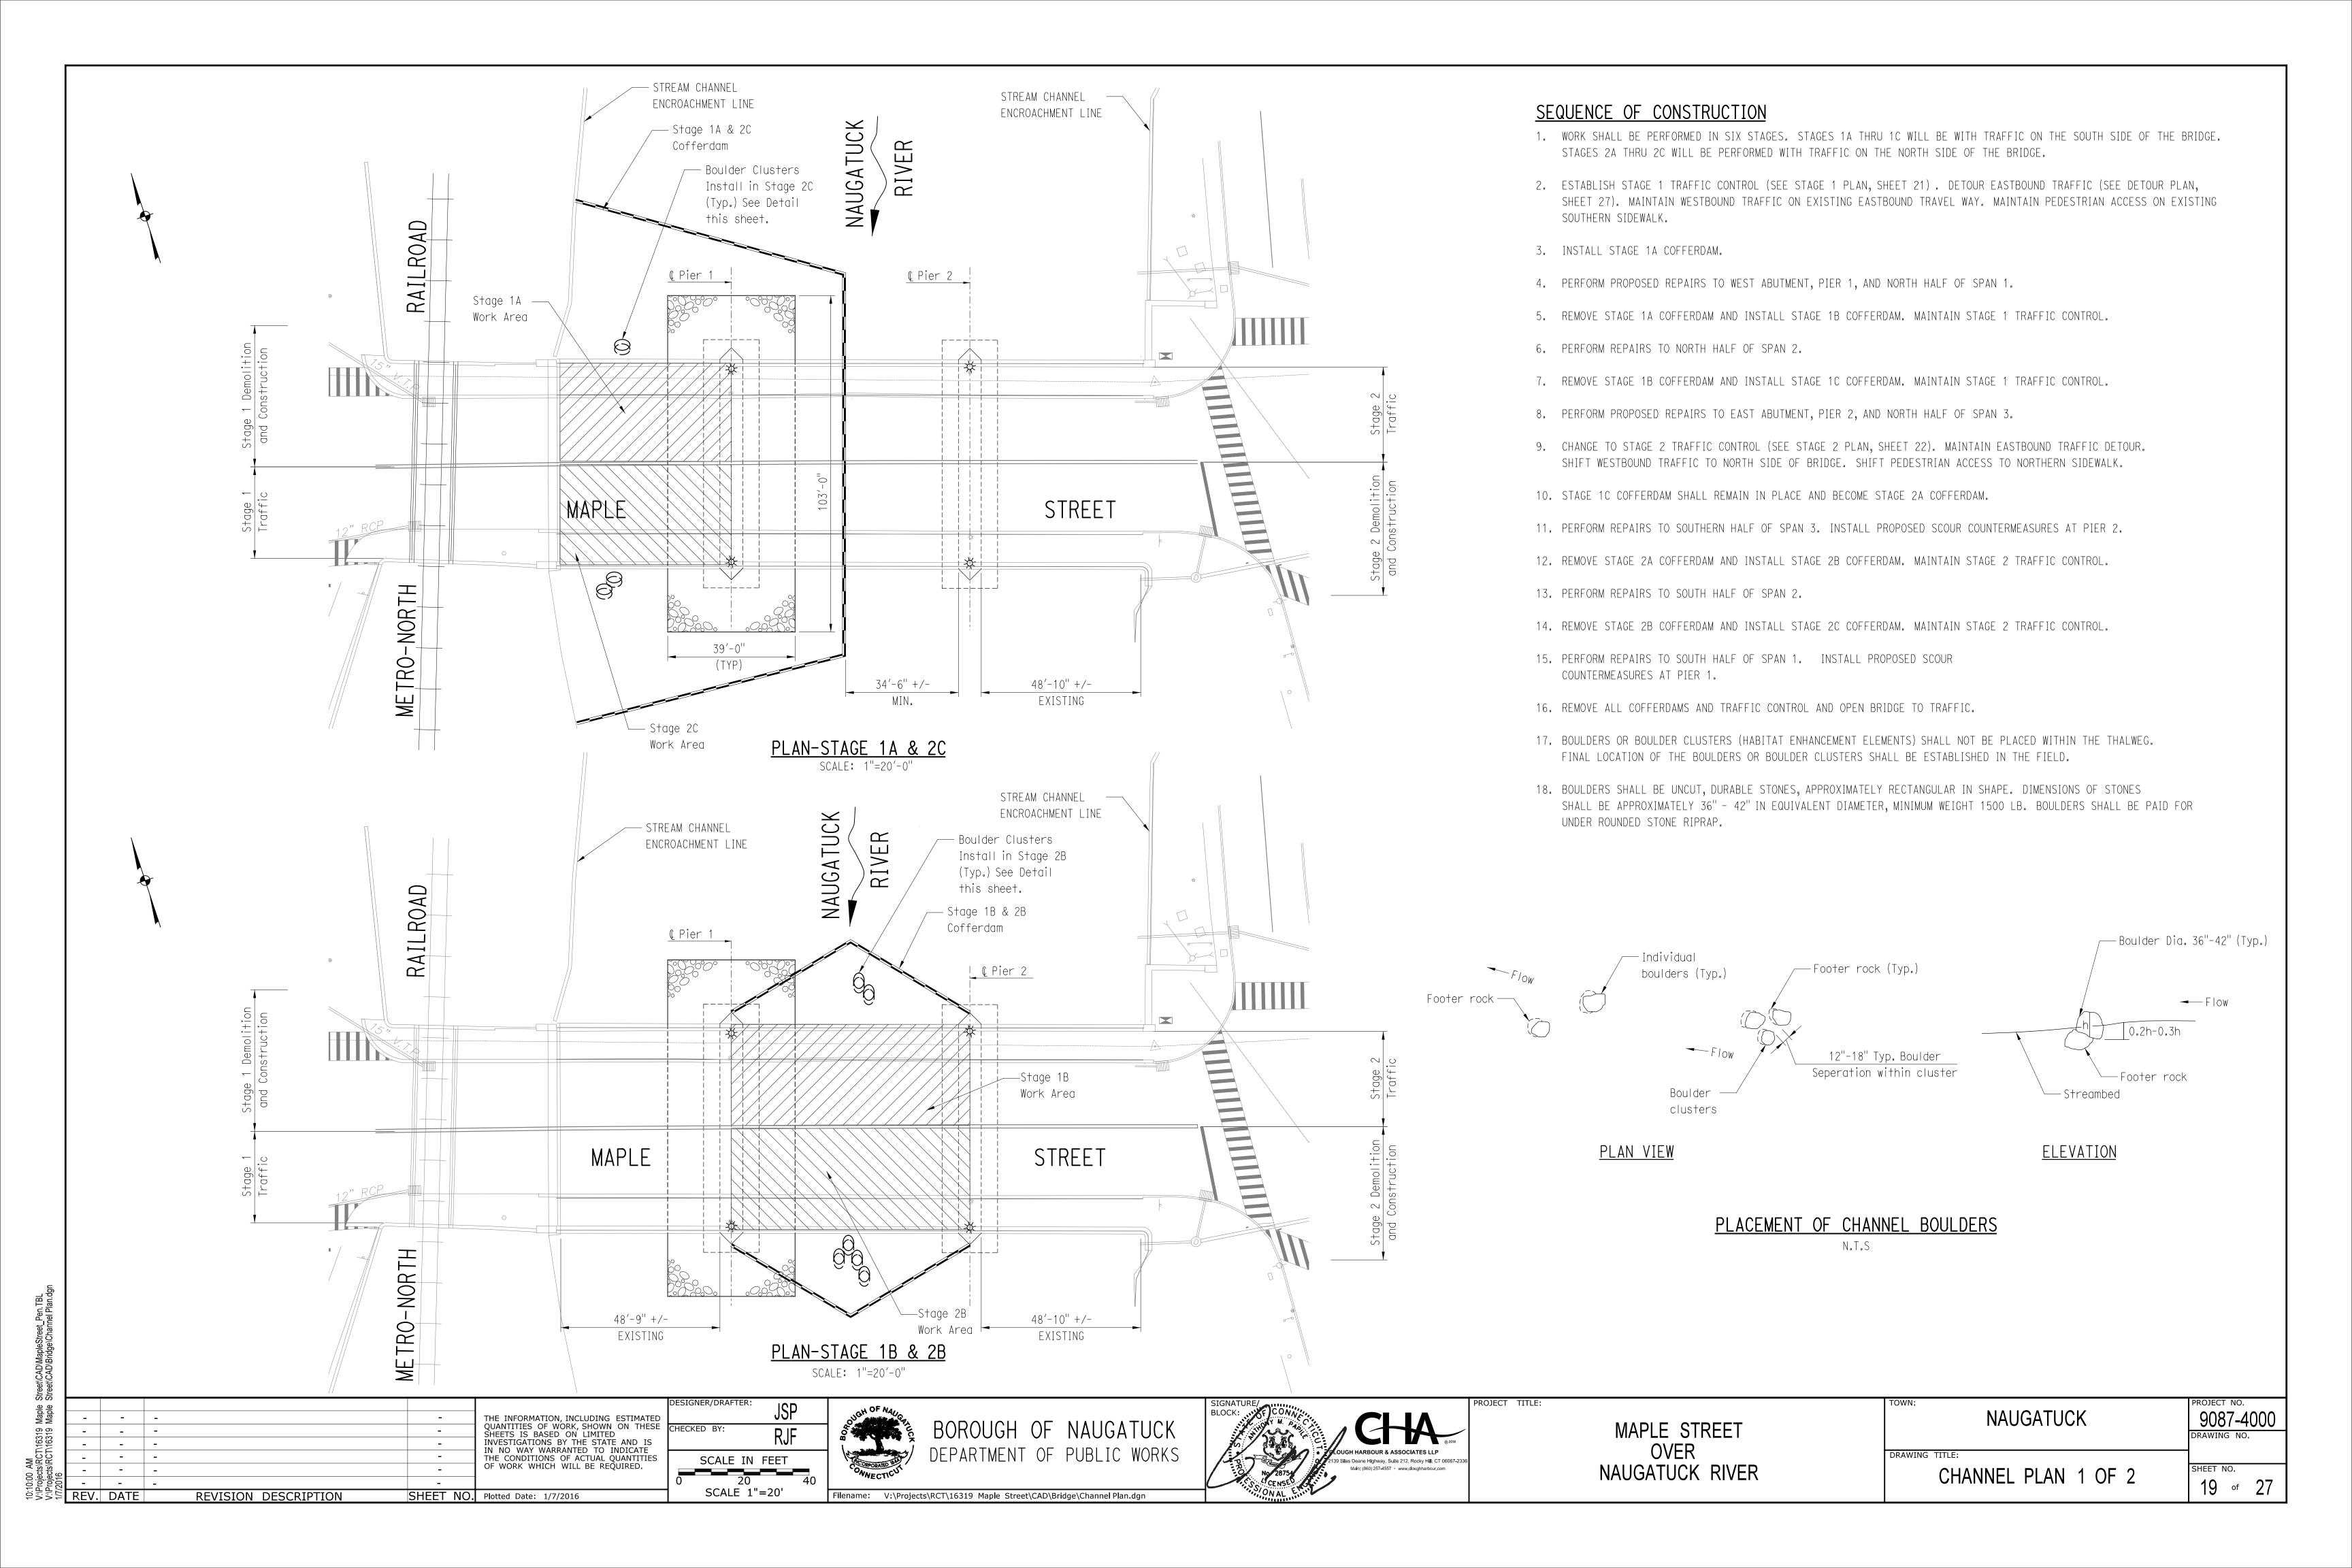PLAN-STAGE 1C & 2A

SCALE: 1"=20'-0"




NOTES:

- 1. UNCONFINED IN-STREAM ACTIVITY IS RESTRICTED TO THE TIME PERIOD OF JUNE 1 THROUGH SEPTEMBER 30.
- 2. ALL MACHINERY, MATERIALS, AND REMOVAL OF SOIL AND DEBRIS REQUIRED FOR THE REPAIR OF THE STRUCTURE AND PLACEMENT OF RIPRAP MUST BE LOWERED OVER THE SIDE OF THE BRIDGE INTO THE COFFERDAM. ALL TOOLS AND MACHINERY SHALL BE REMOVED FROM THE COFFERDAM EVERY NIGHT.
- 3. DEBRIS AND OTHER WASTE RESULTING FROM EQUIPMENT MAINTENANCE AND CONSTRUCTION SHALL NOT BE DISCARDED ON SITE.
- 4. IN ALL AREAS, REMOVAL OF TREES, BUSHES AND OTHER VEGETATION AND DISTURBANCE OF THE SOIL, IS TO BE KEPT TO AN ABSOLUTE MINIMUM WHILE ALLOWING PROPER DEVELOPMENT OF THE SITE.
- 5. CONTRACTOR IS TO BUILD TEMPORARY COFFERDAMS AROUND THE PIER AND WATER SIDE OF THE ABUTMENTS. COFFERDAMS ARE TO CONSIST OF APPROPRIATE MATERIAL, TO CREATE A WATER TIGHT WORK AREA ALLOWING PLACEMENT OF RIPRAP AND REPAIR OF THE SUBSTRUCTURE IN THE DRY. SAND BAGS ARE NOT ALLOWED AS A PRIMARY BARRIER IN THE COFFERDAM. ALL COSTS TO BE PAID FOR UNDER THE PAY ITEM "COFFERDAM AND DEWATERING".
- 6. TEMPORARY COFFERDAM SHALL BE DESIGNED AND INSTALLED TO PROVIDE A MINIMUM HEIGHT ABOVE THE STREAM BED AS NECESSARY TO RETAIN A 2 YEAR STORM EL. 181.6.
- 7. EFFLUENT FROM DEWATERED WORK AREAS SHOULD NOT BE DISCHARGED DIRECTLY TO THE STREAM BUT BE PROCESSED THROUGH PORTABLE SEDIMENT TANK. COSTS TO BE INCLUDED IN THE PAY ITEM "COFFERDAM AND DEWATERING".
- 8. PORTABLE SEDIMENT TANK SHALL HAVE A MINIMUM RETENTION TIME OF AT LEAST 2 HOURS AND SHALL MEET THE SPECIFICATIONS OF 2002 CONNECTICUT GUIDELINES FOR SOIL EROSION AND SEDIMENT CONTROL, SECTION 5-13-11. CONTRACTOR SHALL SUBMIT PROPOSED DETAILS FOR APPROVAL PRIOR TO CONSTRUCTION.
- 9. CONSTRUCTION DEBRIS INSIDE THE COFFERDAM IS TO BE COMPLETELY REMOVED FROM THE RIVER BED PRIOR TO THE REMOVAL OF THE COFFERDAM.
- 10. THE CONTRACTOR SHALL CLEAN SEDIMENT AND DEBRIS FROM ALL DRAINAGE STRUCTURES AND PIPES AT THE COMPLETION OF CONSTRUCTION AND AS REQUESTED BY THE RESIDENT ENGINEER.
- 11. FOLLOWING COMPLETION OF CONSTRUCTION, THE CONTRACTOR SHALL REPAIR ALL ERODED AREAS AND DISPLACED RIPRAP.
- 12. A CONSTRUCTION SEQUENCING PLAN AND A WATER HANDLING PLAN INCLUDING A CONTINGENCY PLAN FOR FLOOD EVENTS MUST BE SUBMITTED IN WRITING TO THE ENGINEER AND APPROVED BY THE ENGINEER PRIOR TO THE COMMENCEMENT OF ANY CONSTRUCTION IN A WATERWAY.
- 13. CONTRACTOR MAY PROPOSE ALTERNATE METHODS OF CONSTRUCTION FOR APPROVAL.

TEMPORARY HYDRAULIC SUMMARY DATA	
DESCRIPTION	VALUES
AVERAGE DAILY FLOW	390 CFS
AVERAGE SPRING FLOW	790 CFS
2-YEAR FREQUENCY DISCHARGE	5,500 CFS
TEMPORARY DESIGN DISCHARGE	5,500 CFS
TEMPORARY DESIGN FREQUENCY	2 YR
TEMPORARY WATER SURFACE ELEVATION- UPSTREAM	181.6 FT
TEMPORARY WATER SURFACE ELEVATION- DOWNSTREAM	178.5 FT

REV. DATE

REVISION DESCRIPTION

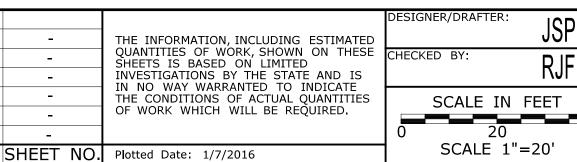




BOROUGH OF NAUGATUCK DEPARTMENT OF PUBLIC WORKS





MAPLE STREET **OVER** NAUGATUCK RIVER

TOWN:	NAUGATUCK	
DRAWING	TITLE:	

CHANNEL PLAN 2 OF 2

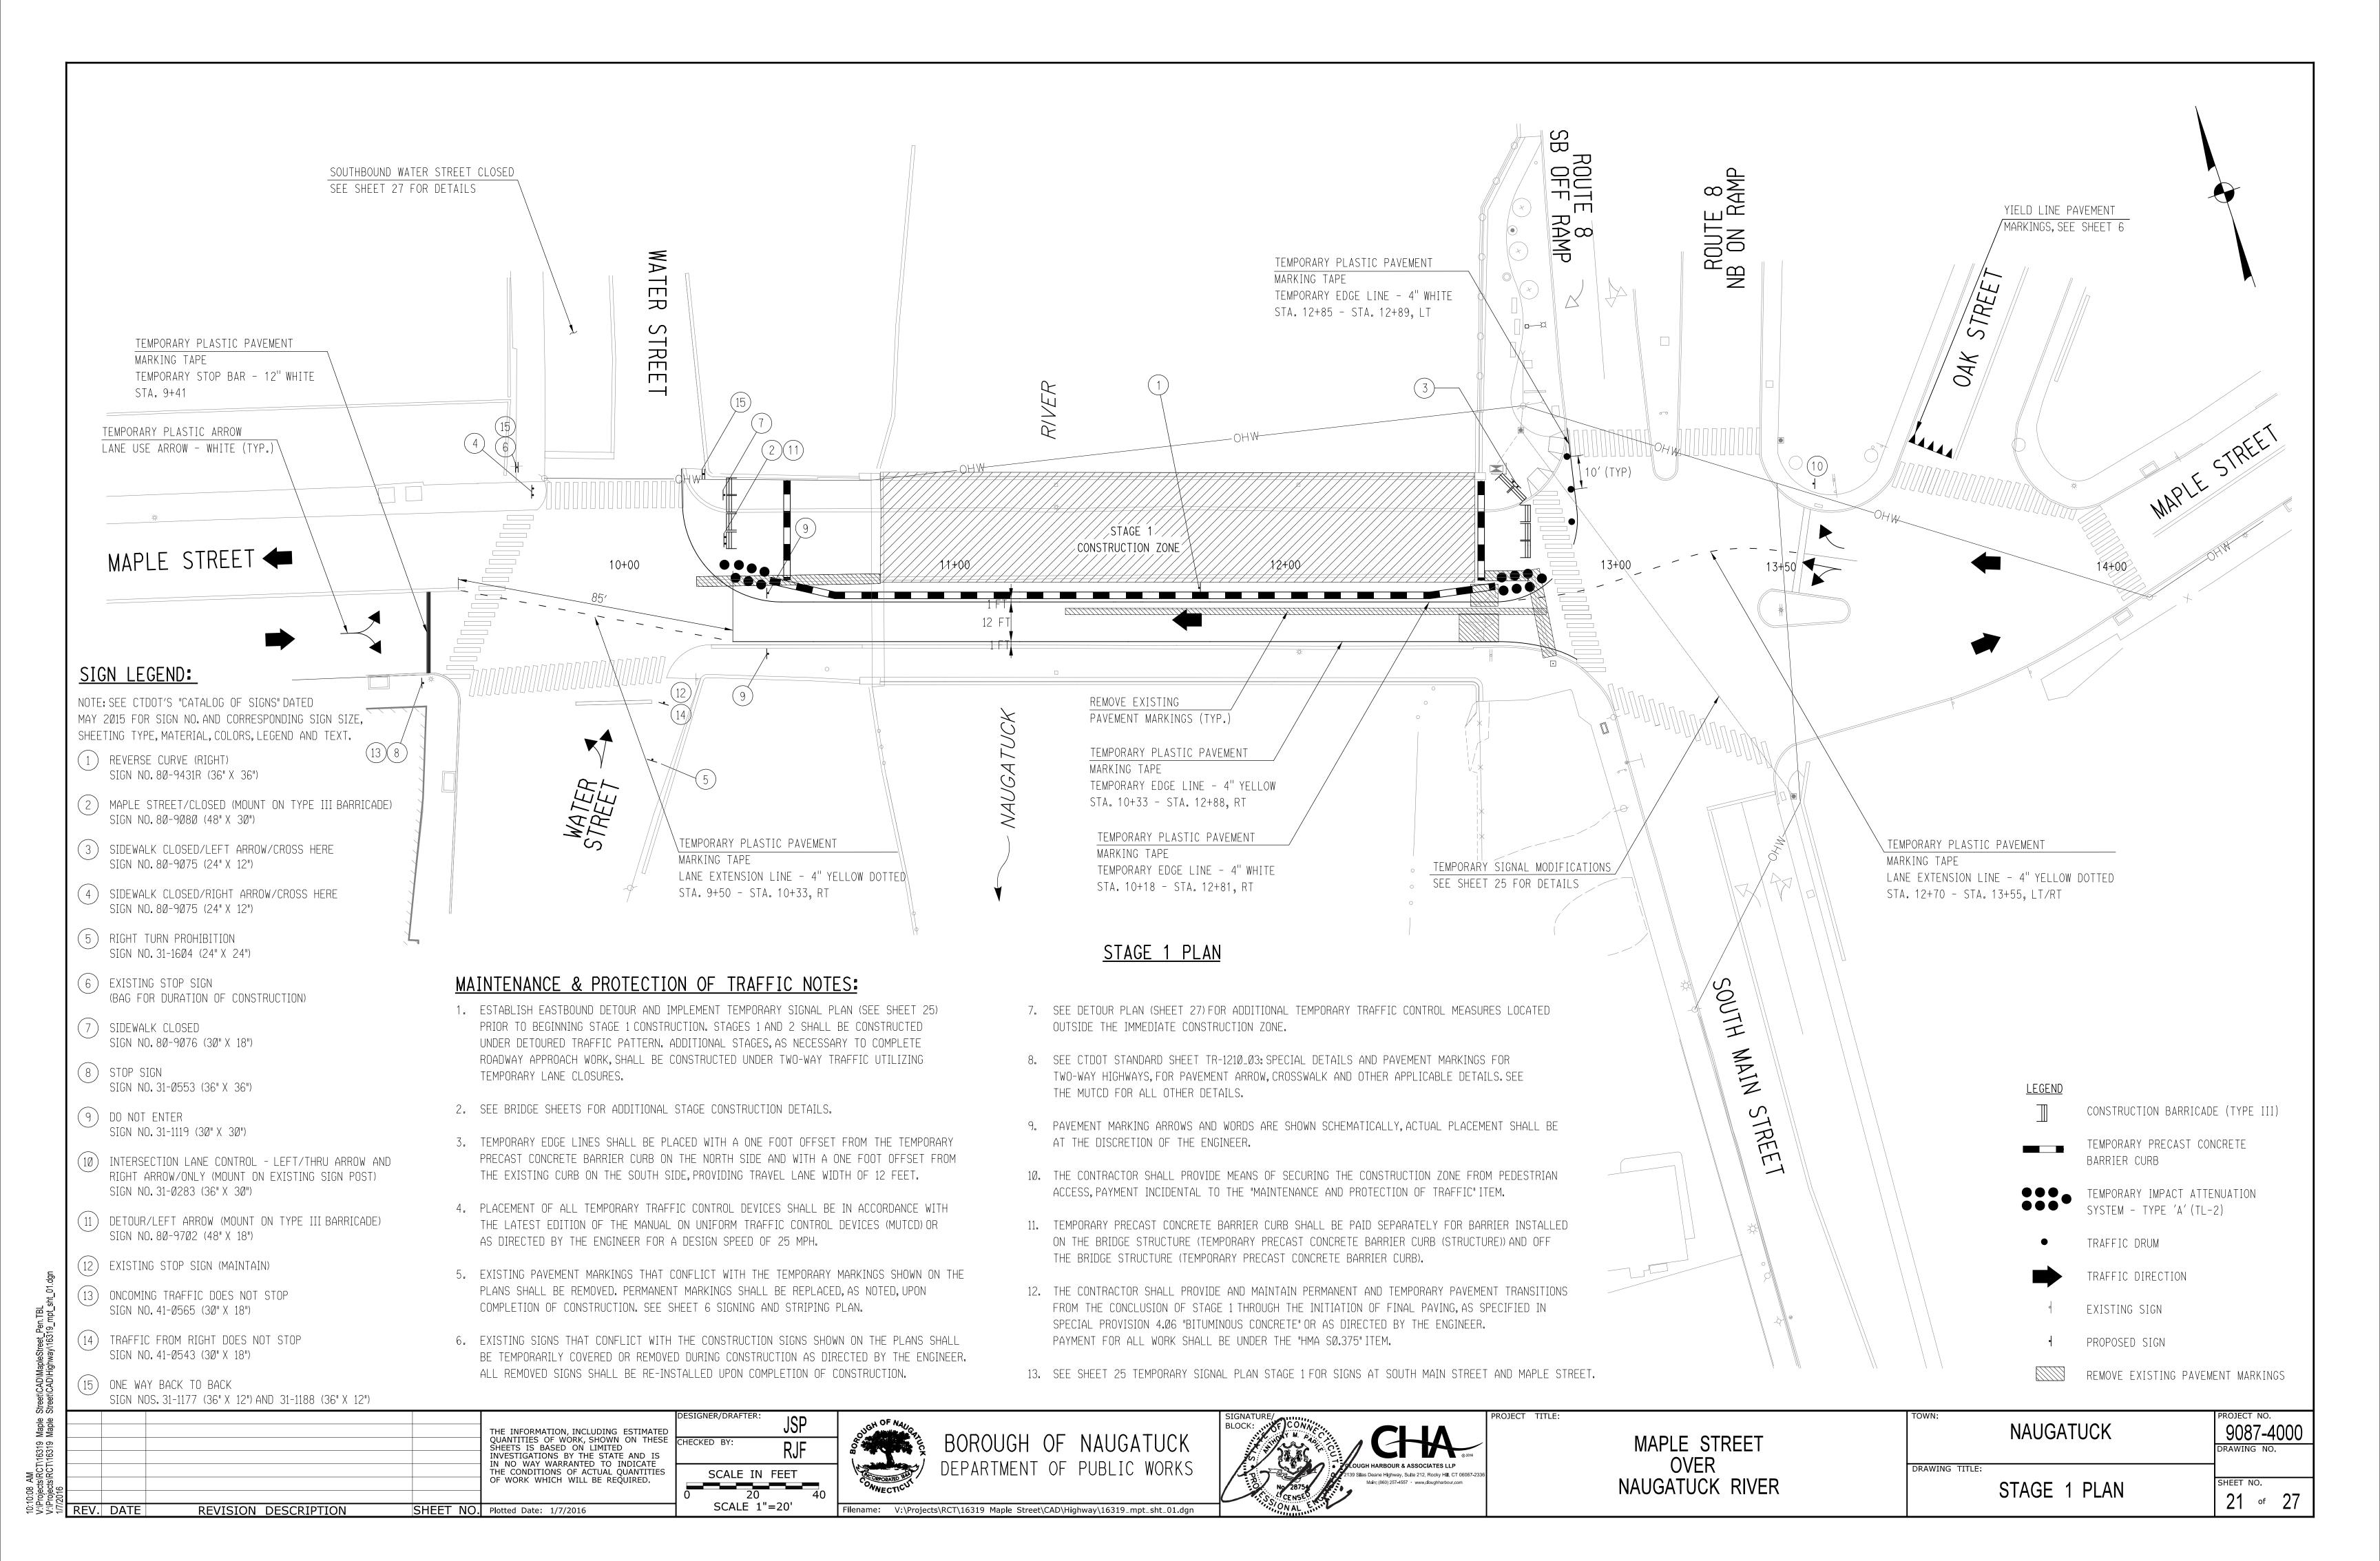

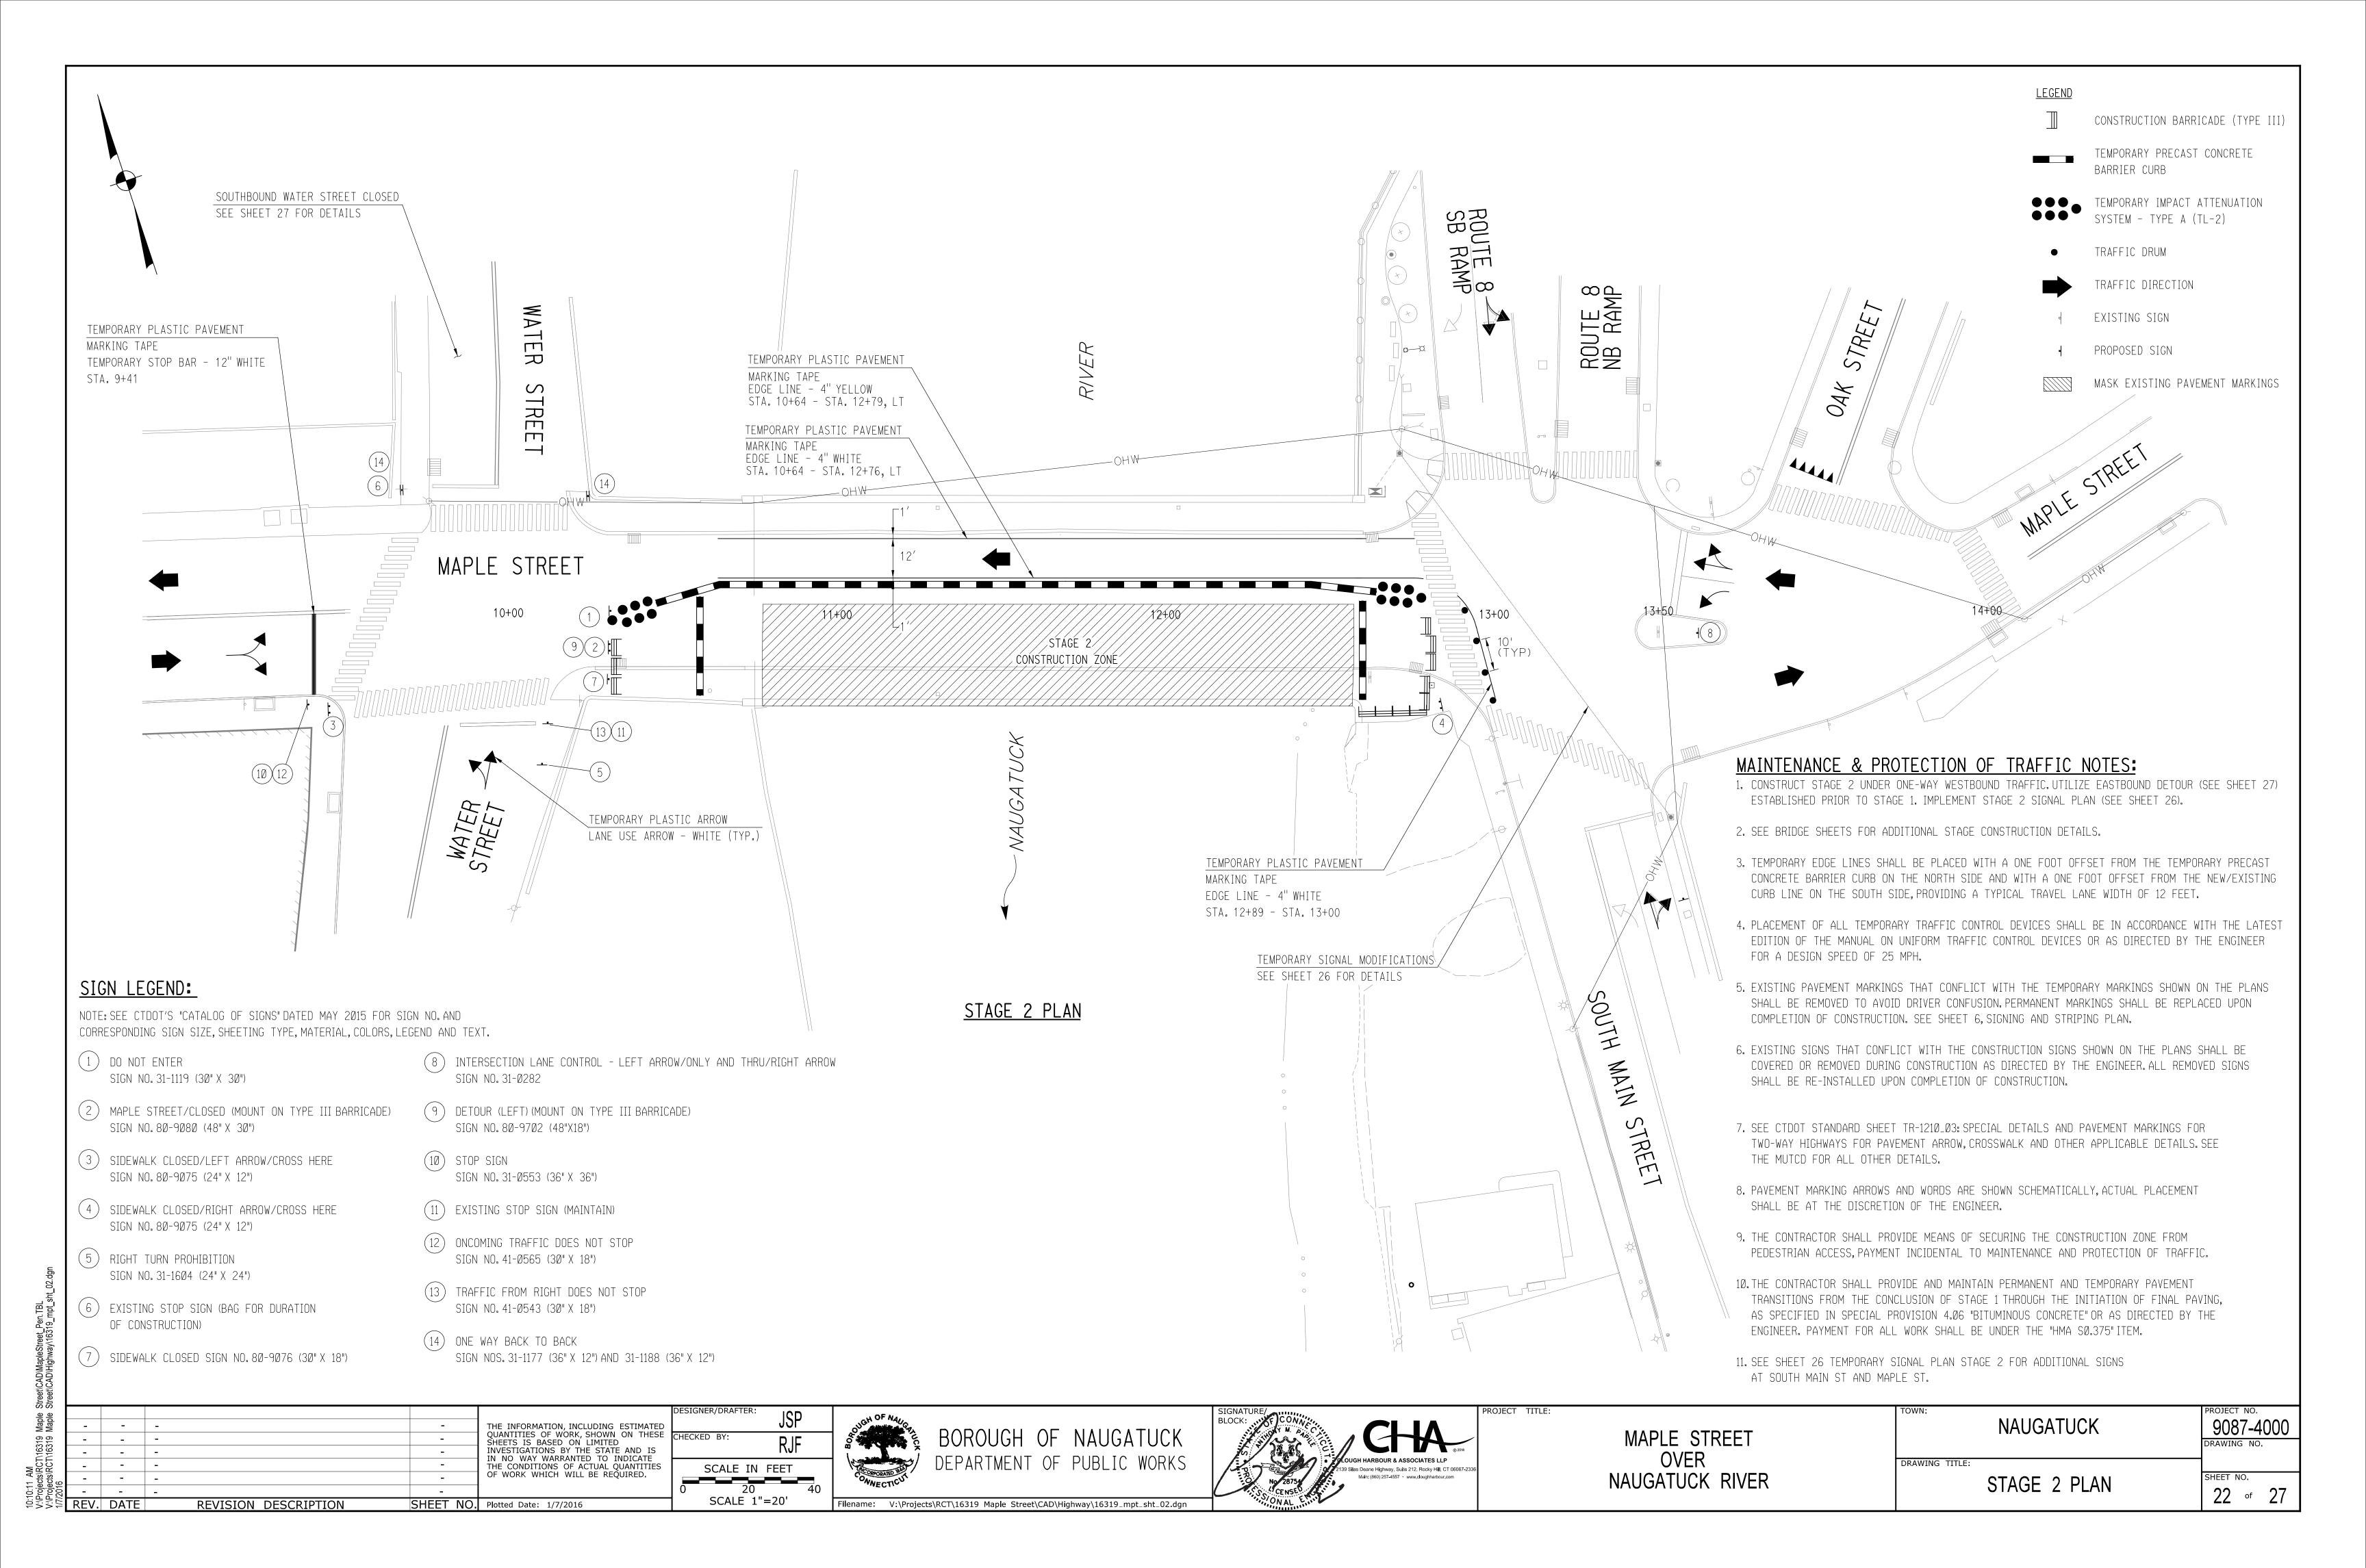

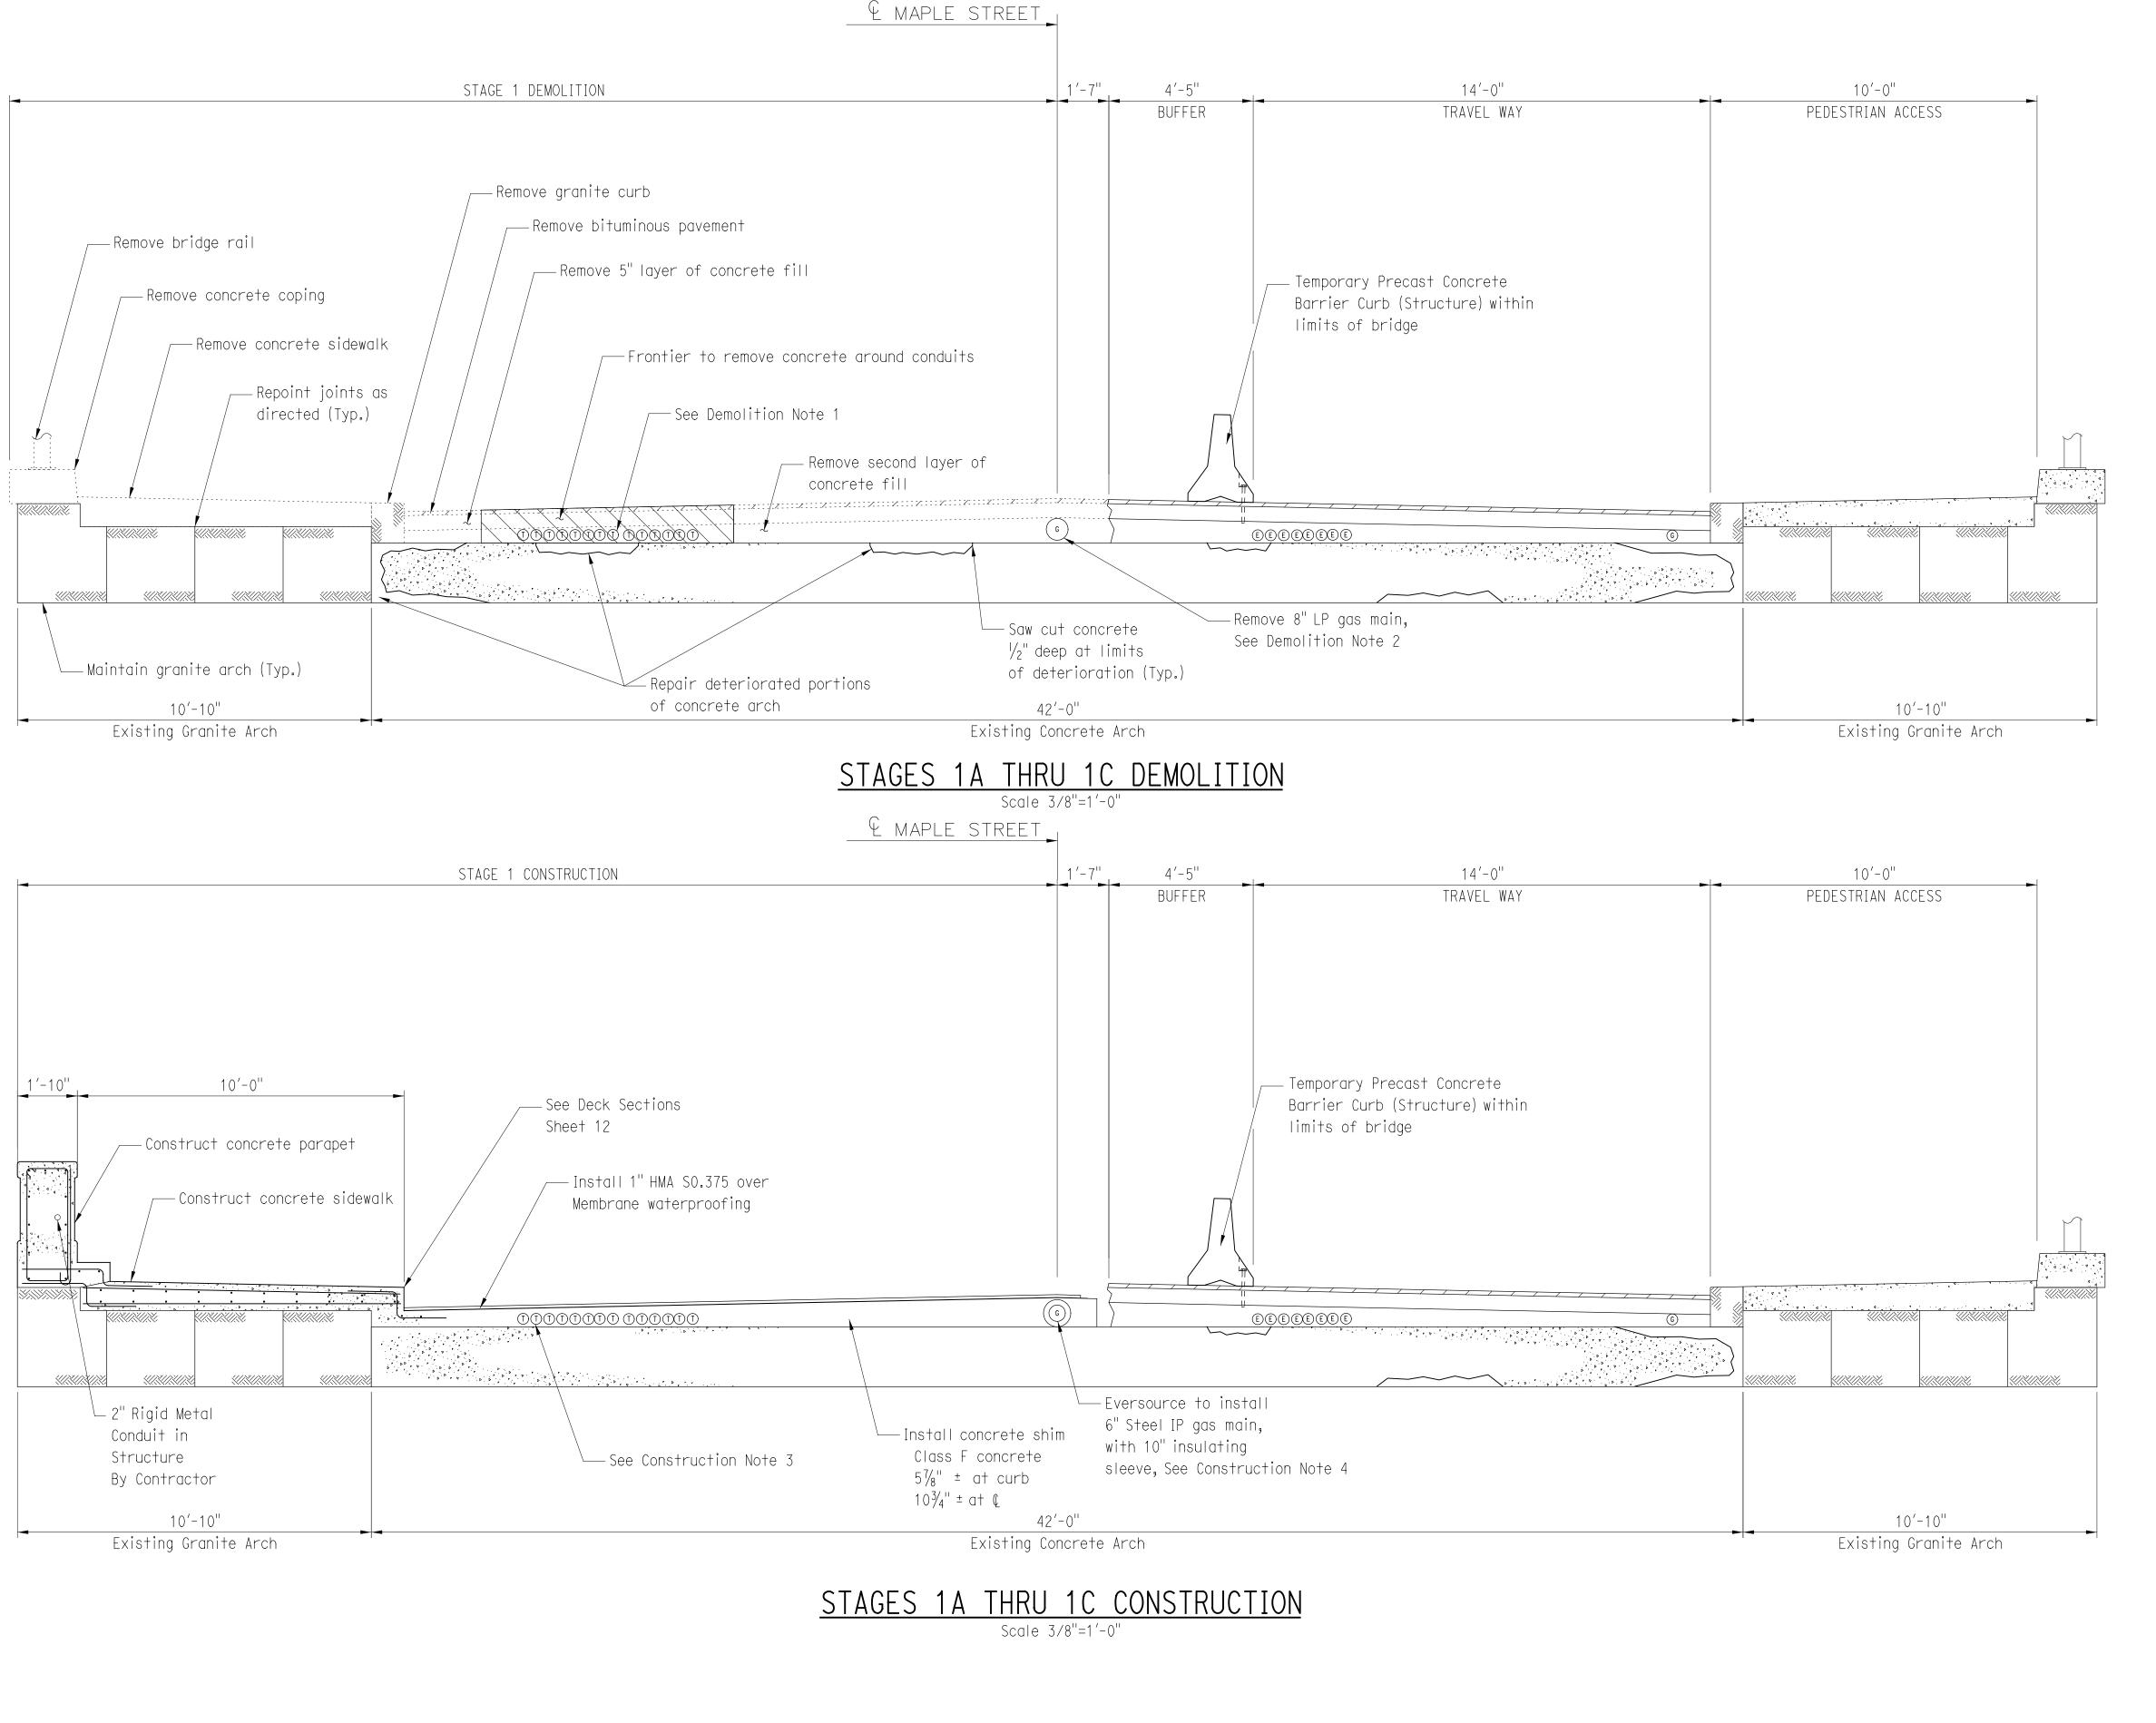


STAGE 1 DEMOLITION NOTES:

- 1. THE CONTRACTOR SHALL ESTABLISH THE LOCATION OF TELEPHONE CONDUITS PRIOR TO ANY EXCAVATION ACTIVITIES IN THE AREA. THE CONTRACTOR SHALL STOP EXCAVATION WITHIN 1 FOOT OF TELEPHONE CONDUITS AND CONTACT FRONTIER. THE CONTRACTOR SHALL FURNISH A PROTECTED AREA WITHIN THE CONSTRUCTION ZONE TO PLACE THE TELEPHONE CONDUITS. THE CONDUITS SHALL BE PROTECTED UNTIL THE CONDUIT IS TO BE POSITIONED WITHIN THE CONCRETE FILL. SEE STAGE 1 CONSTRUCTION NOTES FOR DETAILS. FRONTIER OR SUBCONTRACTOR WILL BREAK OUT THE CONDUITS AND MOVE THE CONDUITS INTO THE PROTECTED AREA. THE CONTRACTOR SHALL MAINTAIN AND PROTECT TELEPHONE CONDUIT SERVICE THROUGH THE WORK ZONE. FRONTIER RESERVES THE RIGHT TO REVIEW THE METHOD BEING USED IN SUPPORTING THE STRUCTURE. THE STRUCTURE IS TO BE DESIGNED BY A STATE OF CONNECTICUT LICENSED PROFESSIONAL ENGINEER. THIS WORK SHALL BE PAID UNDER THE "TEMPORARY SUPPORT FOR EXISTING TELEPHONE DUCTS" ITEM. FRONTIER CONTACT: TOM DELORENZO (203) 238-5202.
- 2. EVERSOURCE, OR SUBCONTRACTOR OF THEIR PROVISION, SHALL PERFORM ALL WORK ASSOCIATED WITH THE ABANDONMENT OF THE EXISTING 8" LOW PRESSURE (LP) GAS MAIN. CONTRACTOR SHALL REMOVE THE ABANDONED GAS MAIN INCIDENTAL TO "REMOVAL OF EXISTING MASONRY" ITEM. EVERSOURCE CONTACT: ROB PANTALONE (203) 596-3020.
- 3. REMOVAL OF BRIDGE RAILING TO BE PAID BY THE "REMOVAL OF EXISTING METAL BRIDGE RAIL" ITEM.
- 4. REMOVAL OF BITUMINOUS BRIDGE PAVEMENT, CONCRETE COPING, CONCRETE SIDEWALK, AND CONCRETE FILL SHALL BE PAID BY THE "REMOVAL OF EXISTING MASONRY" ITEM.
- 5. CONCRETE AND CONDUITS REMOVED BY FRONTIER OR EVERSOURCE WILL NOT BE PAID FOR.
- 6. SEE DECK SECTION, SHEET 12, AND ARCH REPAIR DETAIL, SHEET 18, FOR FURTHER DETAILS.
- 7. CONTRACTOR SHALL REMOVE EXISTING LIGHT STANDARDS AND ALL ASSOCIATED ELECTRICAL HARDWARE. ALL WORK ASSOCIATED WITH REMOVAL SHALL BE PAID UNDER THE ITEM "REMOVE LIGHT STANDARD". SEE SPECIAL PROVISIONS FOR FURTHER DETAILS.

STAGE 1 CONSTRUCTION NOTES:

- 1. THE MEMBRANE WATERPROOFING AND HMA SO.375 SHALL BE INSTALLED AT THE END OF STAGE 1. THE FINAL WEARING SURFACE OF DRAINAGE BLANKET, BEDDING, AND CEMENT PAVERS MAY BE PLACED USING TEMPORARY LANE CLOSURES AND SHIFTS AFTER CONCRETE SHIM IS COMPLETE IN STAGE 2.
- 2. CONCRETE PARAPET, CONCRETE SIDEWALK, AND CONCRETE SHIM SHALL BE PAID BY THE "CLASS F CONCRETE" ITEM.
- 3. FRONTIER SHALL POSITION AND SECURE TELECOMMUNICATION CONDUITS PRIOR TO THE INSTALLATION OF THE CONCRETE SHIM. THE CONTRACTOR SHALL COORDINATE THE SETTING OF THE CONDUITS IN THE STRUCTURE PRIOR TO POURING CONCRETE. THIS WORK SHALL BE INCLUDED IN THE "TEMPORARY SUPPORT FOR EXISTING TELEPHONE DUCTS" ITEM.
- 4. EVERSOURCE SHALL POSITION AND SECURE 6" STEEL INTERMEDIATE PRESSURE (I. P.) GAS MAIN PRIOR TO THE INSTALLATION OF THE CONCRETE SHIM. THE CONTRACTOR SHALL COORDINATE THE SETTING OF THE GAS MAIN PRIOR TO POURING CONCRETE. THIS WORK SHALL BE INCIDENTAL TO THE "CLASS F CONCRETE" ITEM.
- 5. SEE DECK SECTIONS, SHEET 12 AND ARCH REPAIR DETAIL, SHEET 18 FOR FURTHER DETAILS.
- 6. THE CONTRACTOR SHALL PROVIDE AND MAINTAIN PERMANENT AND TEMPORARY PAVEMENT TRANSITIONS FROM THE CONCLUSION OF STAGE 1 THROUGH THE INITIATION OF FINAL PAVING, AS SPECIFIED IN SPECIAL PROVISION 4.06, OR AS DIRECTED BY THE ENGINEER. PAYMENT FOR ALL WORK SHALL BE UNDER THE "HMA SO.375" ITEM.
- 7. THE CONTRACTOR SHALL INSTALL 2" RIGID METAL CONDUIT IN STRUCTURE AS SHOWN ON UTILITY PLAN, SHEET 7 AND DECK SECTIONS, SHEET 12 AND IN CONFORMANCE WITH THE SPECIAL PROVISIONS. THE CONTRACTOR SHALL SET CONDUIT IN STRUCTURE PRIOR TO POURING CONCRETE. EXPANSION FITTINGS SHALL BE INSTALLED AT ALL EXPANSION JOINTS. THIS WORK SHALL BE INCIDENTAL TO THE "2" RIGID METAL CONDUIT" ITEMS.

THE INFORMATION, INCLUDING ESTIMATED QUANTITIES OF WORK, SHOWN ON THESE SHEETS IS BASED ON LIMITED INVESTIGATIONS BY THE STATE AND IS IN NO WAY WARRANTED TO INDICATE THE CONDITIONS OF ACTUAL QUANTITIES OF WORK WHICH WILL BE REQUIRED. NAUGATUCK 9087-4000 BOROUGH OF NAUGATUCK MAPLE STREET RJF **OVER** DEPARTMENT OF PUBLIC WORKS DRAWING TITLE: 9 Silas Deane Highway, Suite 212, Rocky Hill, CT 06067-2 NAUGATUCK RIVER Main: (860) 257-4557 · www.doughharbour.com SHEET NO. STAGE 1 CROSS SECTIONS SCALE AS NOTED 23 of 27 REVISION DESCRIPTION SHEET NO. Plotted Date: 1/7/2016 REV. DATE Filename: V:\Projects\RCT\16319 Maple Street\CAD\Highway\16319_mpt_section1.dgn

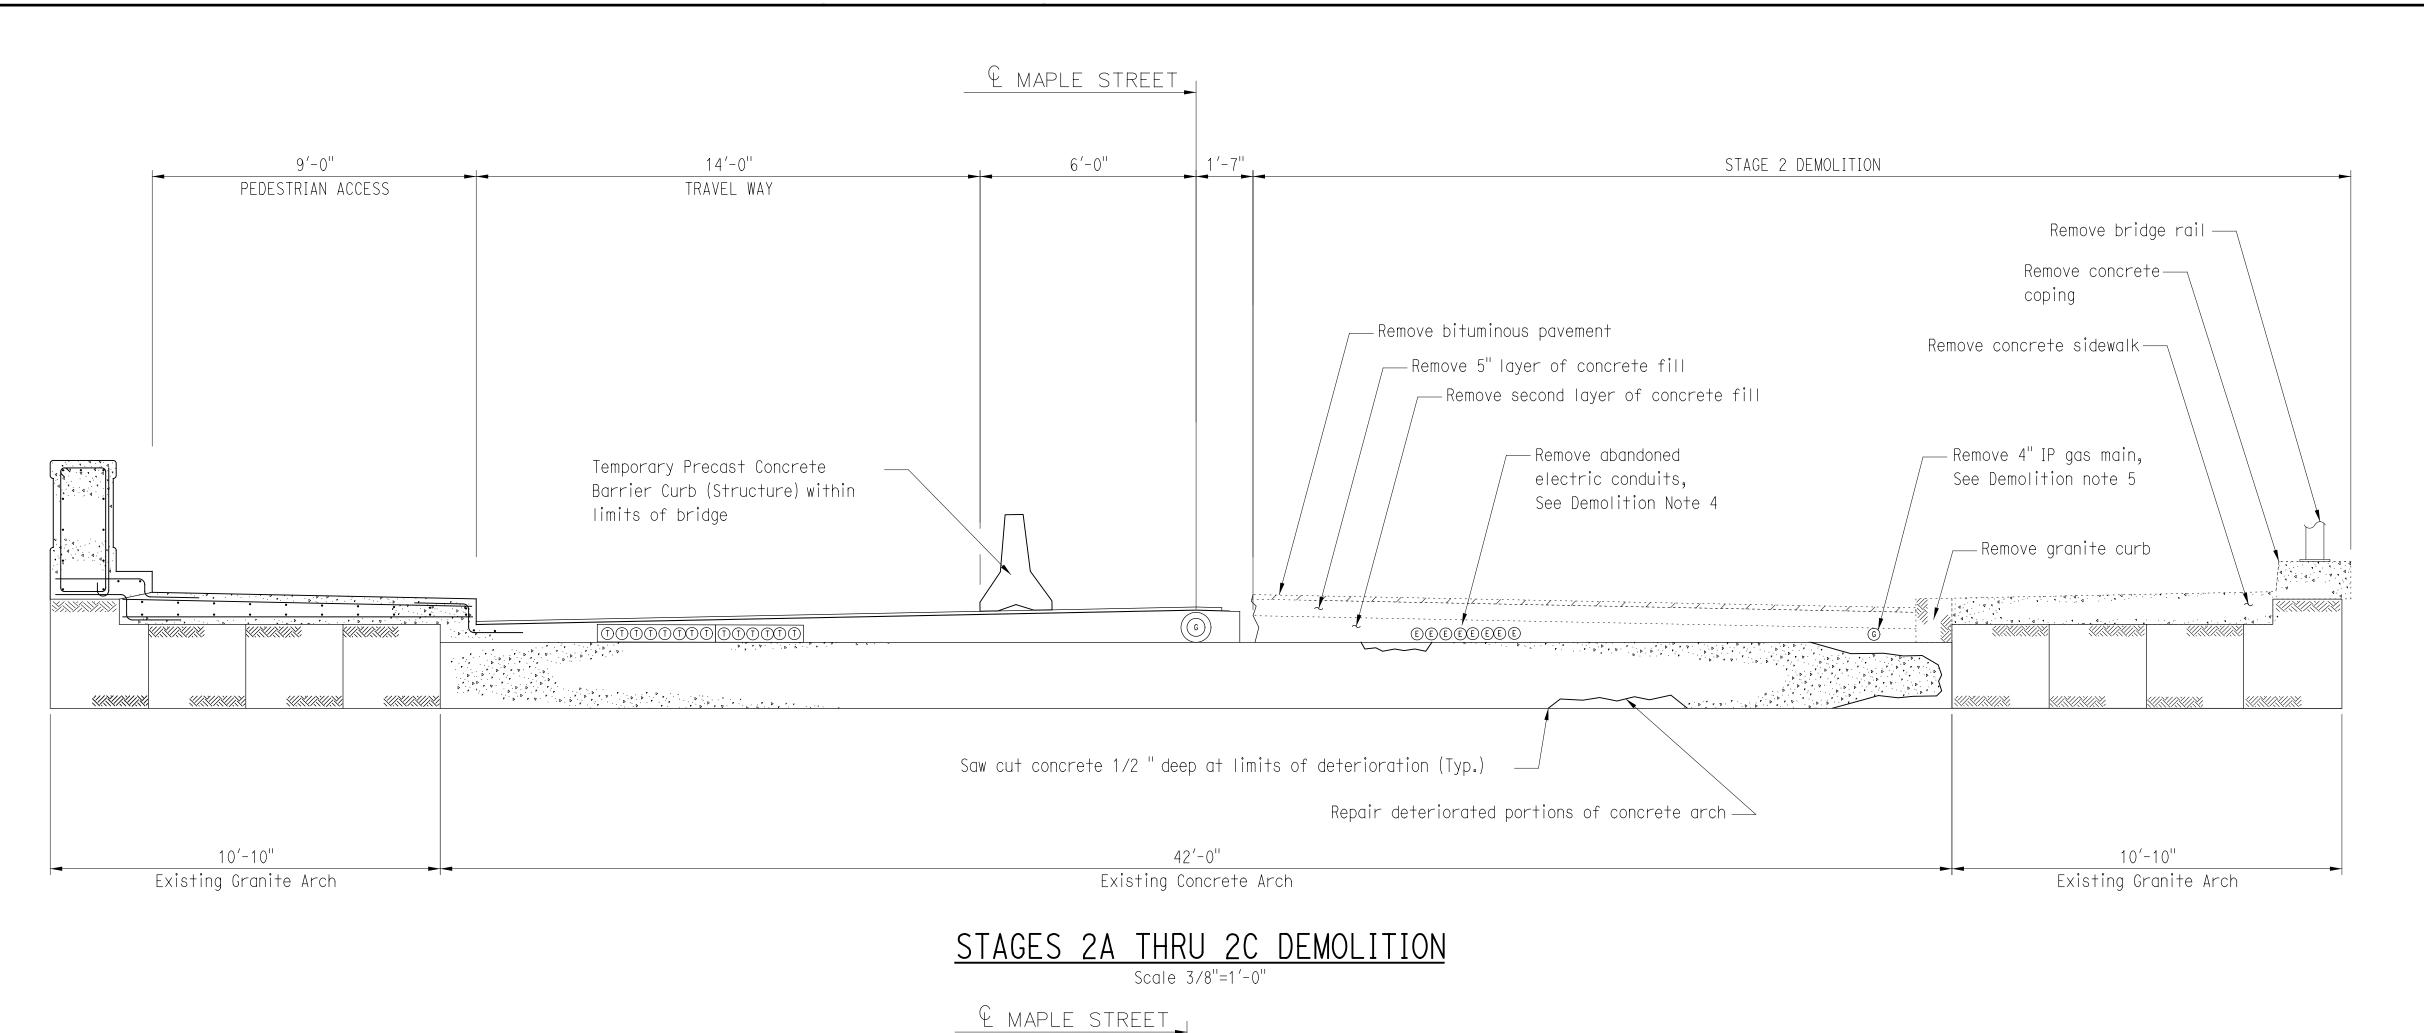


STAGE 2 DEMOLITION NOTES:

- 1. REMOVAL OF BRIDGE RAILING TO BE PAID BY THE "REMOVAL OF EXISTING METAL BRIDGE RAIL" ITEM.
- 2. REMOVAL OF BITUMINOUS BRIDGE PAVEMENT, CONCRETE COPING, CONCRETE SIDEWALK, AND CONCRETE FILL SHALL BE PAID BY THE "REMOVAL OF EXISTING MASONRY" ITEM.
- 3. CONCRETE AND CONDUITS REMOVED BY UTILITIES WILL NOT BE PAID FOR.
- 4. EVERSOURCE TO ABANDON CONDUIT DUCT PRIOR TO STAGE 2 DEMOLITION. SEE UTILITY PLAN (SHEET 7) FOR FURTHER DETAILS. CONTACT EVERSOURCE FOR CONFIRMATION PRIOR TO EXCAVATION IN THIS AREA. REMOVAL OF ABANDONED ELECTRIC CONDUITS AND COORDINATION WITH EVERSOURCE SHALL BE INCIDENTAL TO THE "REMOVAL OF EXISTING MASONRY" ITEM.
- 5. EVERSOURCE OR SUBCONTRACTOR OF THEIR PROVISION, SHALL PERFORM ALL WORK ASSOCIATED WITH THE ABANDONMENT OF THE EXISTING 4" INTERMEDIATE PRESSURE (I.P.) GAS MAIN. CONTRACTOR SHALL REMOVE THE ABANDONED GAS MAIN INCIDENTAL TO THE "REMOVAL OF EXISTING MASONRY" ITEM.
- 6. SEE DECK SECTIONS, SHEET 12 AND ARCH REPAIR DETAIL, SHEET 18 FOR FURTHER DETAILS.
- 7. CONTRACTOR SHALL REMOVE EXISTING LIGHT STANDARDS AND ALL ASSOCIATED ELECTRICAL HARDWARE. ALL WORK ASSOCIATED WITH REMOVAL SHALL BE PAID UNDER THE "REMOVE LIGHT STANDARD" ITEM. SEE SPECIAL PROVISIONS FOR FURTHER DETAILS.

STAGE 2 CONSTRUCTION NOTES:

- 1. THE FINAL WEARING SURFACE OF DRAINAGE BLANKET, BEDDING, AND CEMENT PAVERS SHALL BE PLACED USING TEMPORARY LANE CLOSURES AND SHIFTS AFTER CONCRETE SHIM IS COMPLETE.
- 2. 5" FIBERGLASS CONDUIT HEAVY WALL SHALL BE CONFORM TO THE SPECIAL PROVISIONS.
 THE CONTRACTOR SHALL SET CONDUITS IN STRUCTURE PRIOR TO POURING CONCRETE.
 EXPANSION FITTINGS SHALL BE INSTALLED AT ALL EXPANSION JOINTS. THIS WORK SHALL
 BE INCIDENTAL TO THE "5" FIBERGLASS CONDUIT HEAVY WALL" ITEM. MECHANICAL
 SPACERS SHALL BE INSTALLED EVERY 8 LONGITUDINAL FEET (ON CENTER). MECHANICAL
 SPACERS AND WORK ASSOCIATED WITH SECURING THE CONDUITS SHALL BE INCLUDED IN
 THE "5" FIBERGLASS CONDUIT HEAVY WALL" ITEM. THIS WORK SHALL CONFORM TO THE
 SPECIAL PROVISIONS. ALL FITTINGS AND JOINTS SHALL BE APPROVED, BY THE
 MANUFACTURER, FOR USE WITH THE TYPE OF CONDUIT.
- 3. 4" POLYVINYL CHLORIDE CONDUIT IN STRUCTURE SHALL CONFORM TO THE SPECIAL PROVISIONS. CONTRACTOR SHALL SET CONDUITS IN STRUCTURE PRIOR TO POURING CONCRETE. EXPANSION FITTINGS SHALL BE INSTALLED AT ALL EXPANSION JOINTS. THIS WORK SHALL BE INCLUDED IN THE "4" POLYVINYL CHLORIDE CONDUIT IN STRUCTURE" ITEM. MECHANICAL SPACERS SHALL BE INSTALLED EVERY 8 LONGITUDINAL FEET (ON CENTER). MECHANICAL SPACERS AND WORK ASSOCIATED WITH SECURING THE CONDUITS SHALL BE INCLUDED IN THE "4" POLYVINYL CHLORIDE CONDUIT IN STRUCTURE" ITEM. ALL FITTINGS AND JOINTS SHALL BE APPROVED, BY THE MANUFACTURER, FOR USE WITH THE TYPE OF CONDUIT.
- 4. THE CONTRACTOR SHALL INSTALL 2" RIGID METAL CONDUIT IN STRUCTURE AS SHOWN ON UTILITY PLAN, SHEET 7 AND DECK SECTIONS, SHEET 12 AND SHALL CONFORM TO THE SPECIAL PROVISIONS. THE CONTRACTOR SHALL SET CONDUIT IN STRUCTURE PRIOR TO POURING CONCRETE. EXPANSION FITTINGS SHALL BE INSTALLED AT ALL EXPANSION JOINTS. THIS WORK SHALL BE INCLUDED IN THE "2" RIGID METAL CONDUIT" ITEMS. ALL FITTINGS AND JOINTS SHALL BE APPROVED, BY THE MANUFACTURER, FOR USE WITH THE TYPE OF CONDUIT.
- 5. SEE DECK SECTIONS, SHEET 12 AND ARCH REPAIR DETAIL, SHEET 18 FOR FURTHER DETAILS.

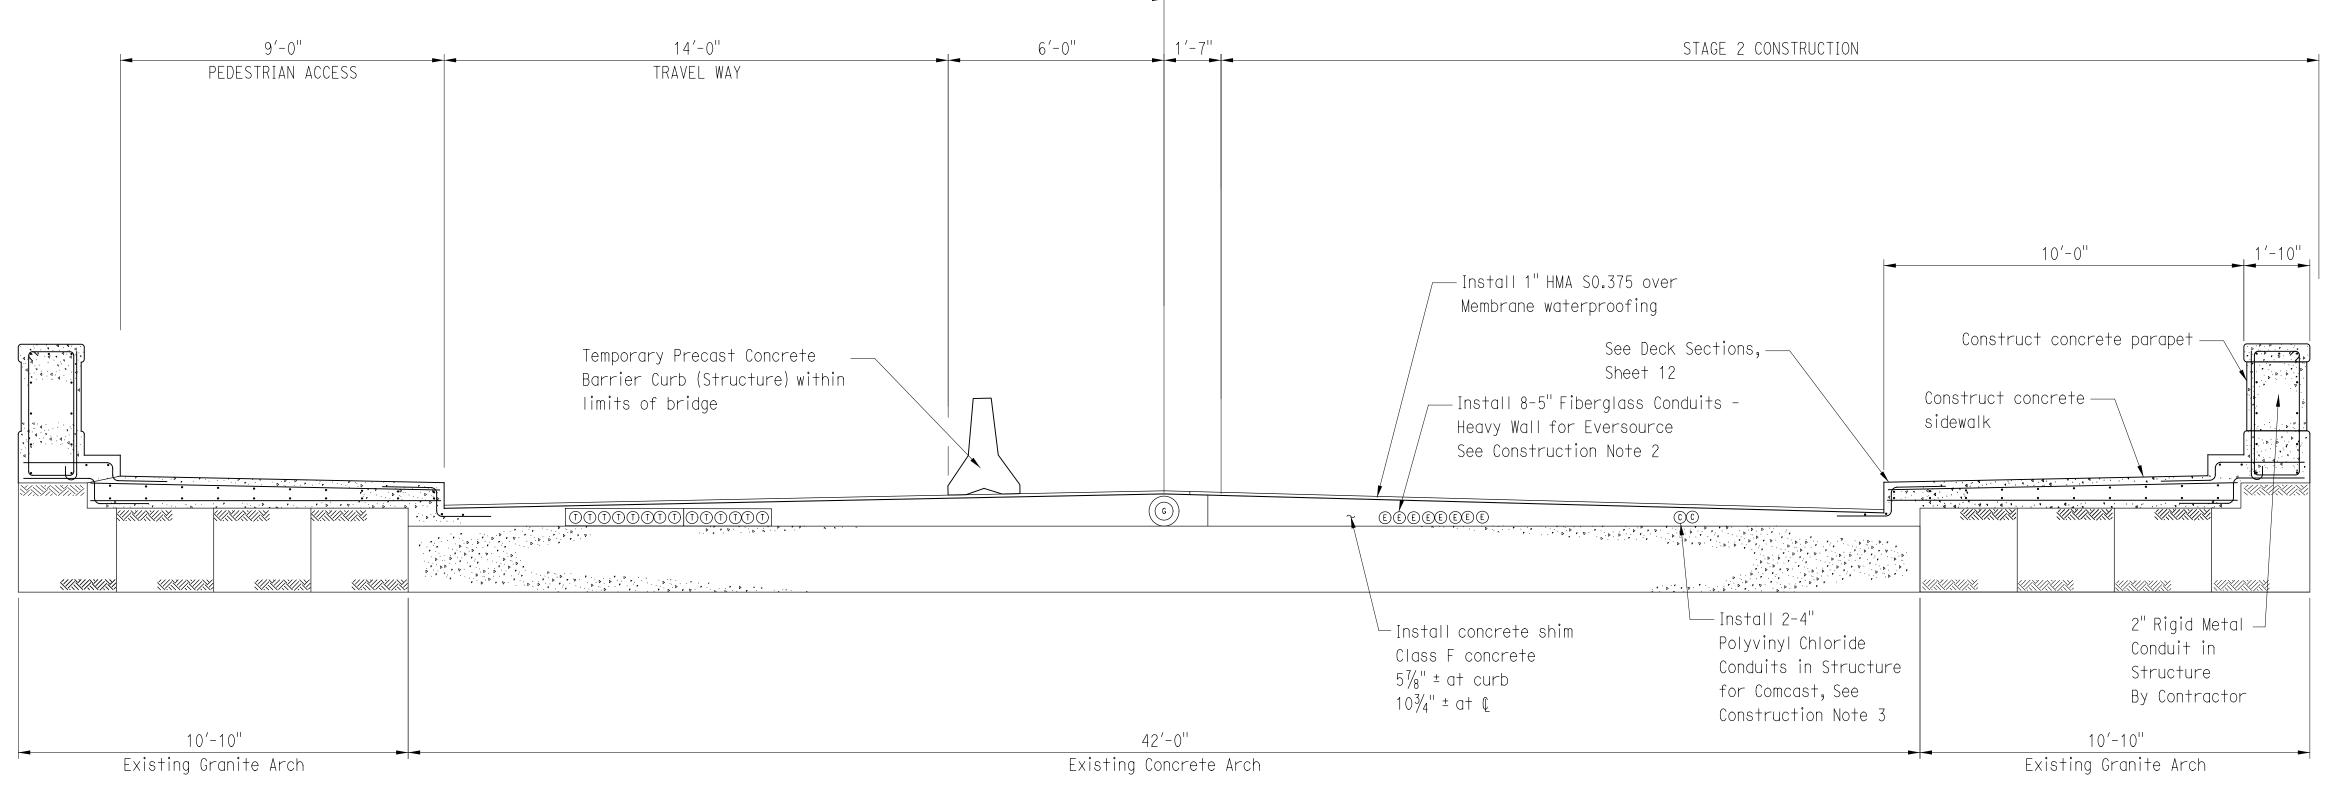

STAGES 2A THRU 2C CONSTRUCTION

Scale 3/8"=1'-0"

THE INFORMATION, INCLUDING ESTIMATED QUANTITIES OF WORK, SHOWN ON THESE SHEETS IS BASED ON LIMITED INVESTIGATIONS BY THE STATE AND IS IN NO WAY WARRANTED TO INDICATE THE CONDITIONS OF ACTUAL QUANTITIES OF WORK WHICH WILL BE REQUIRED.

REV. DATE

REV. DATE

REVISION DESCRIPTION

SHEET NO. Plotted Date: 1/7/2016

CONFORMED NAME OF NAME

RJF

SCALE AS NOTED

BOROUGH OF NAUGATUCK DEPARTMENT OF PUBLIC WORKS

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MAPLE STREET OVER NAUGATUCK RIVER NAUGATUCK


9087-4000

DRAWING TITLE:

STAGE 2 CROSS SECTIONS

SHEET NO.

24 of 27

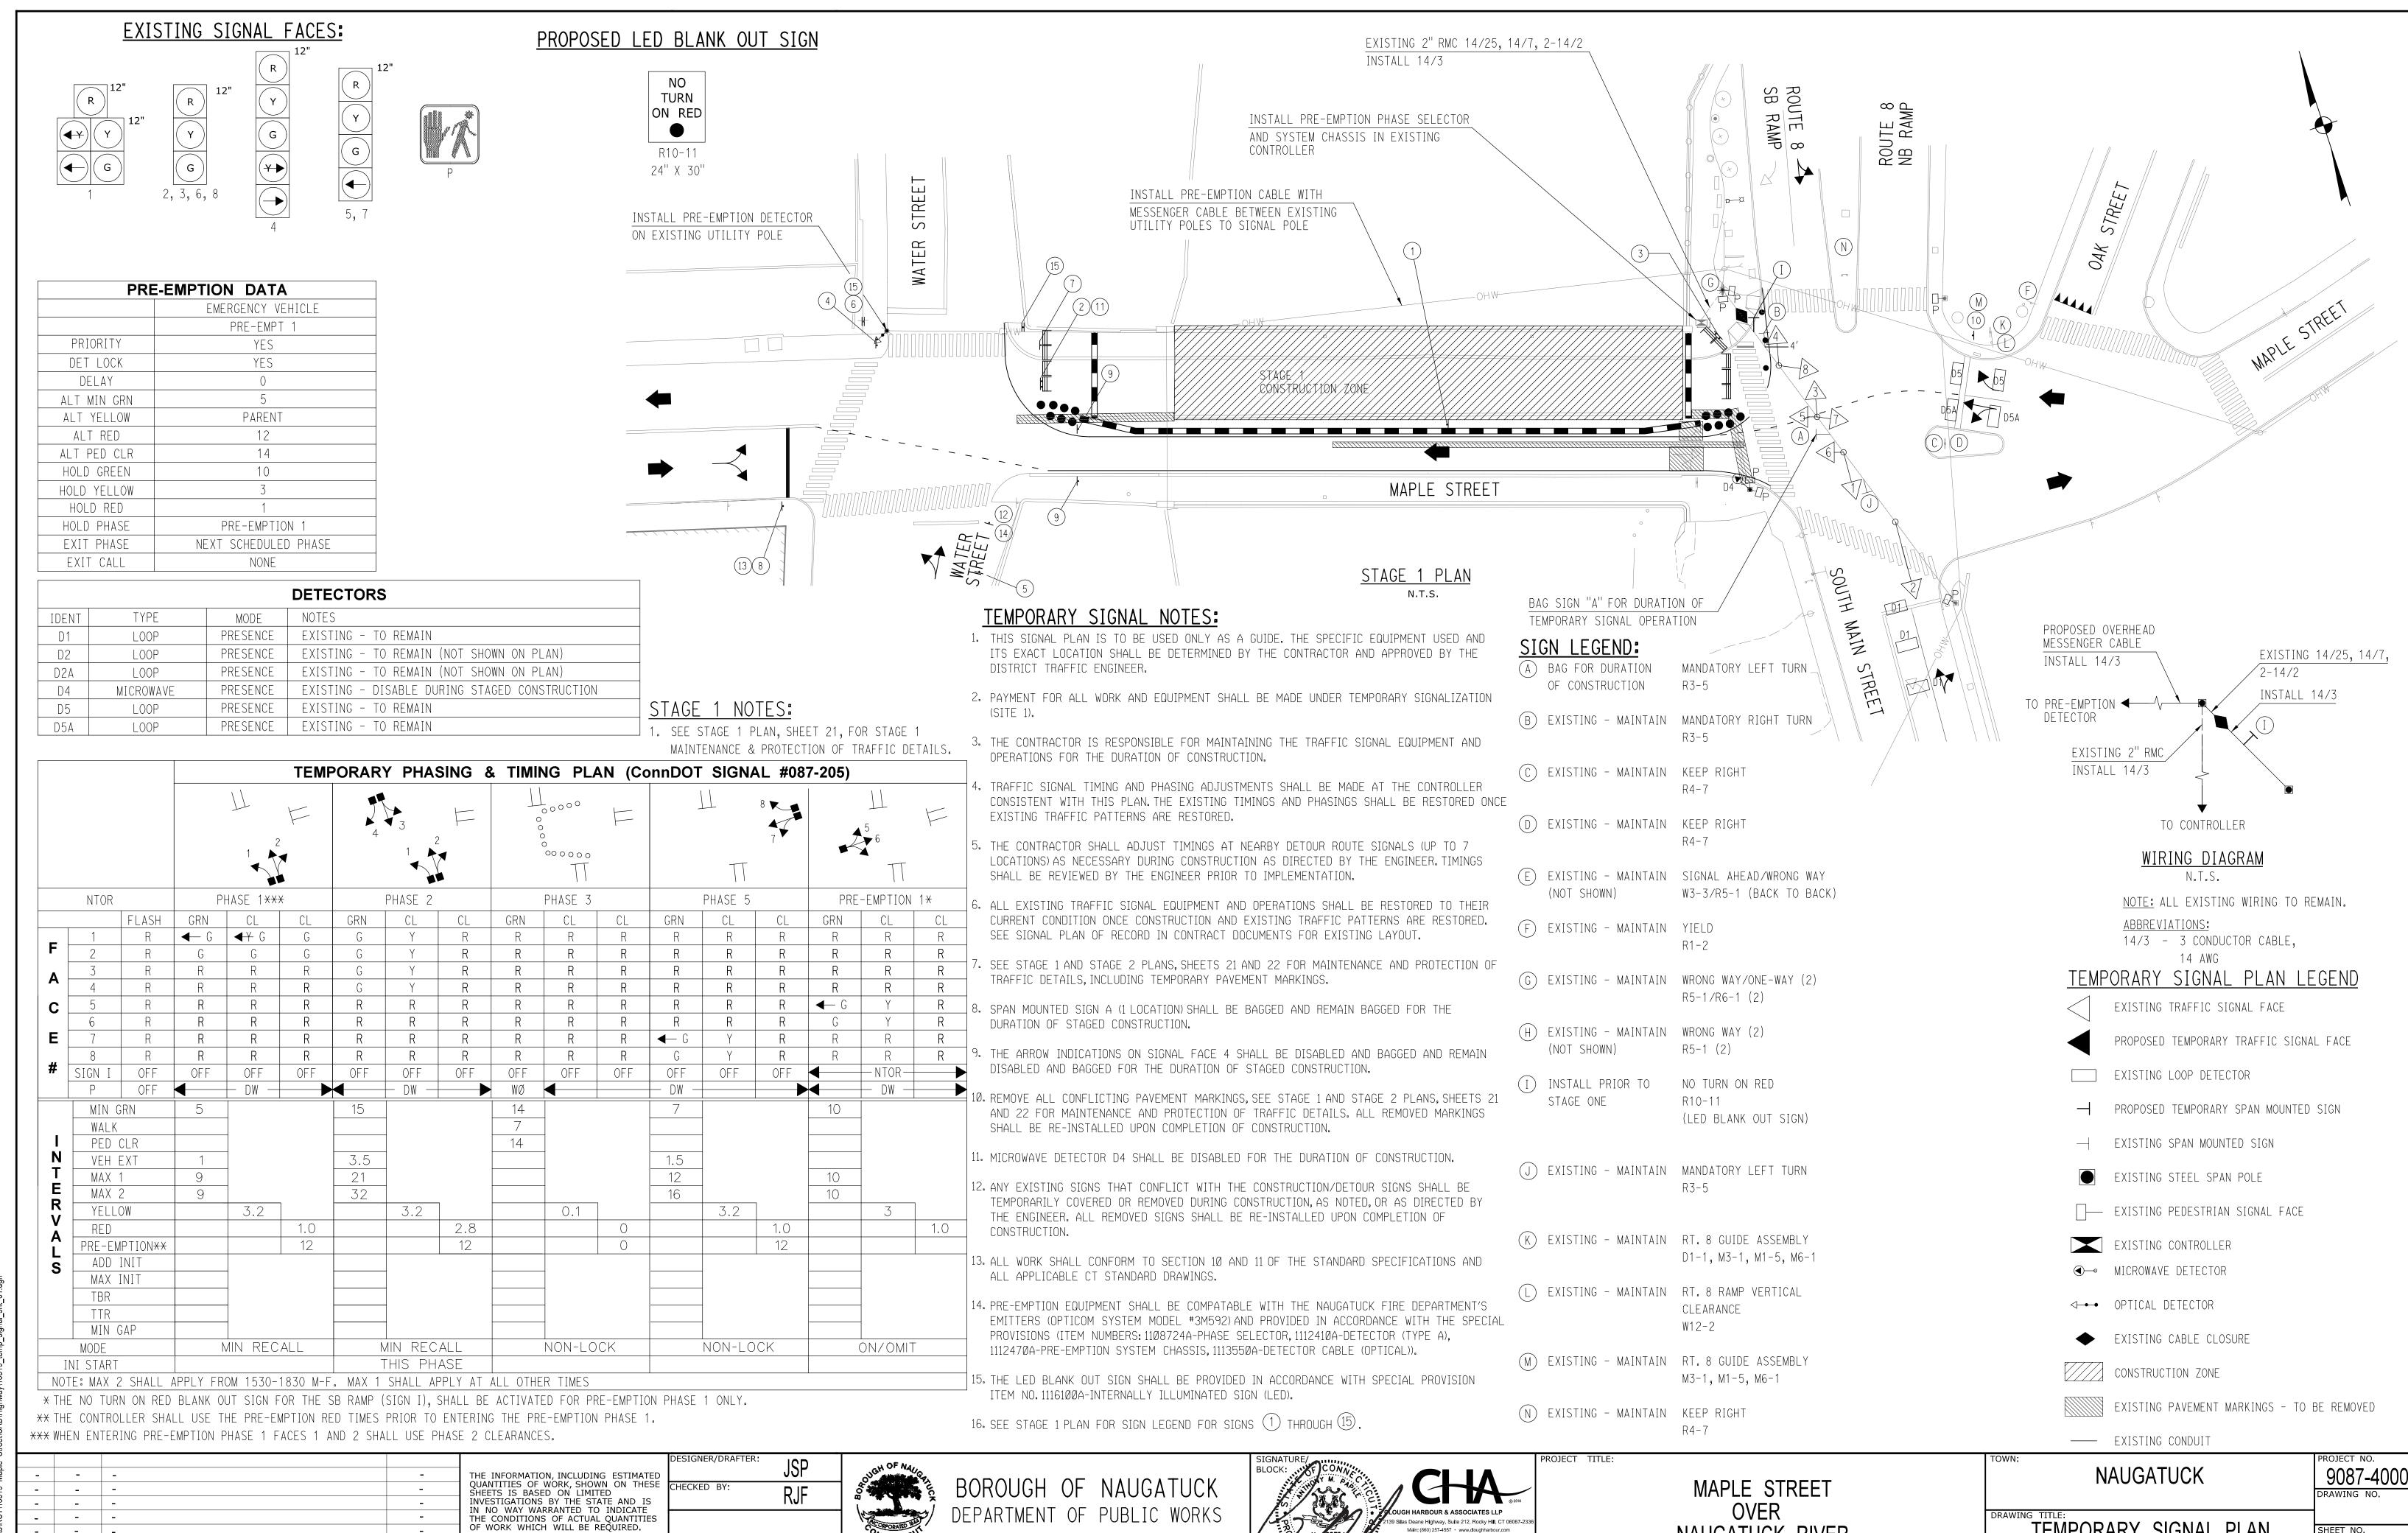

REV. DATE

TEMPORARY SIGNAL PLAN STAGE

SHEET NO.

25 of

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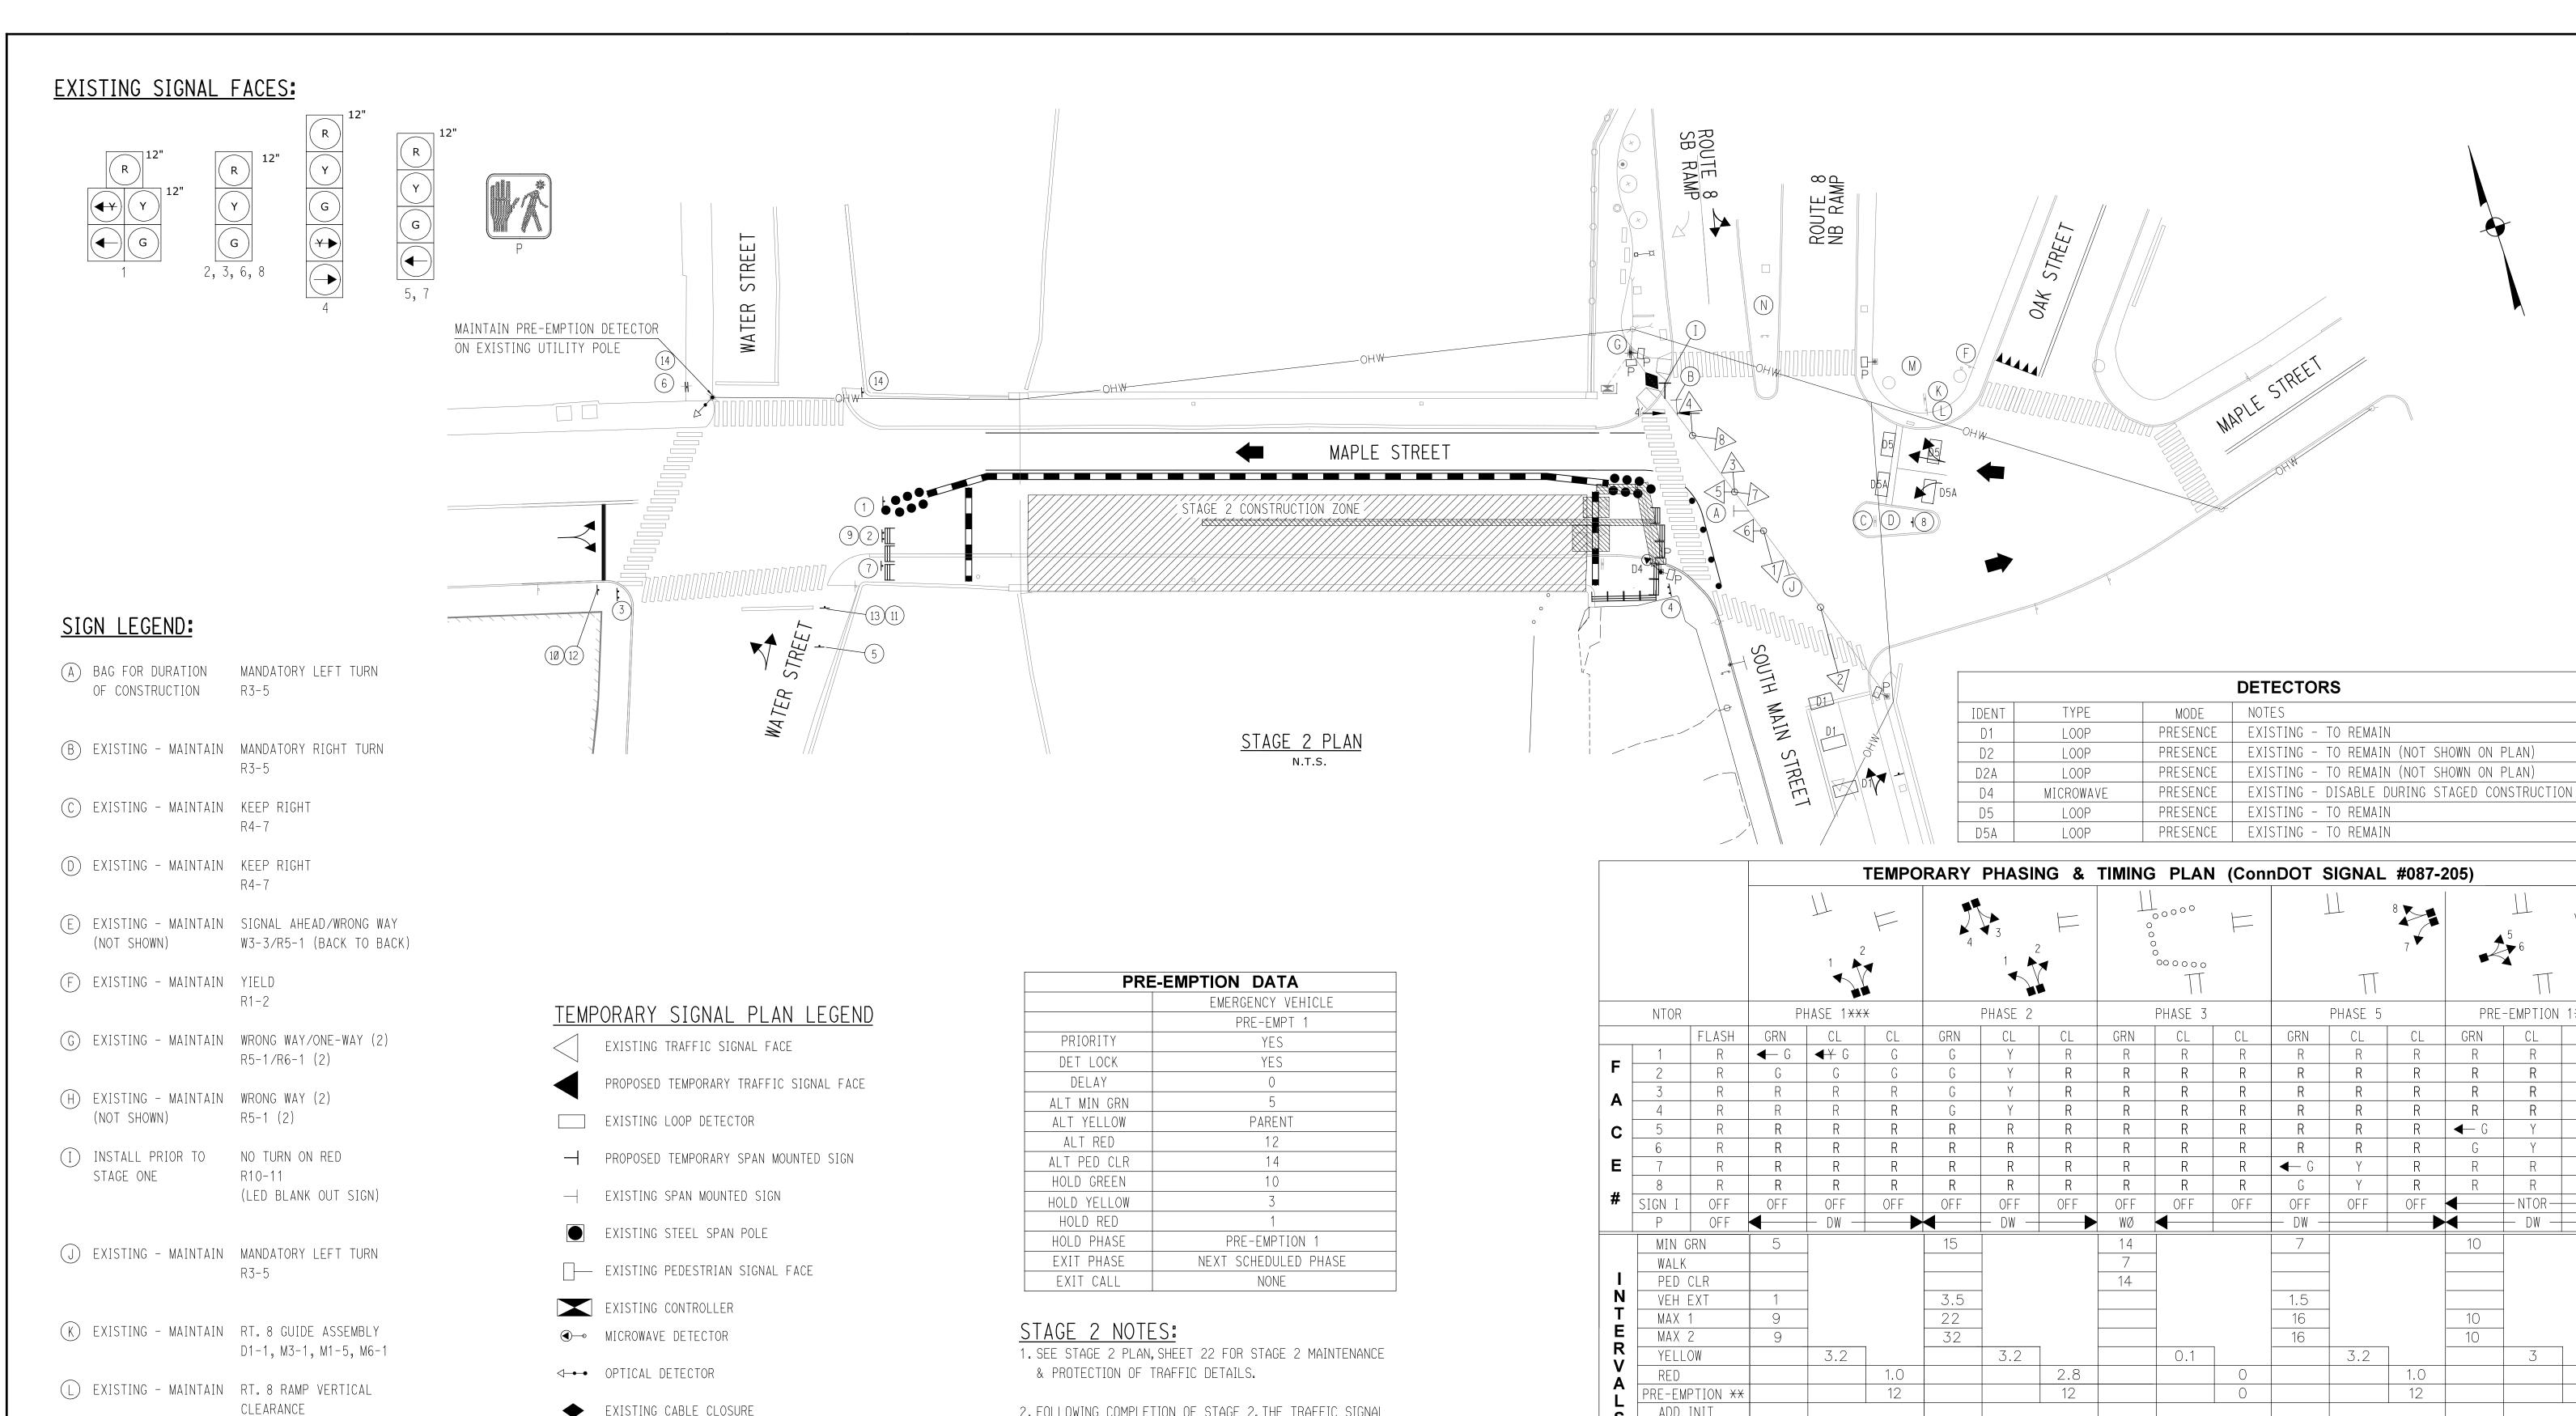
SCALE AS NOTED

SHEET NO. Plotted Date: 1/7/2016

REVISION DESCRIPTION

9 Silas Deane Highway, Suite 212, Rocky Hill, CT 06067-23 Main: (860) 257-4557 · www.doughharbour.com

OVER NAUGATUCK RIVER



◆ EXISTING CABLE CLOSURE 2. FOLLOWING COMPLETION OF STAGE 2, THE TRAFFIC SIGNAL SHALL BE RESTORED TO ITS ORIGINAL CONDITION AND THE CONSTRUCTION ZONE CONTRACTOR SHALL CONTACT CTDOT MAINTENANCE, DISTRICT (M) EXISTING - MAINTAIN RT. 8 GUIDE ASSEMBLY 4 OFFICE (PHONE (860) 585-2710) TO SCHEDULE AN EXISTING PAVEMENT MARKINGS - TO BE REMOVED M3-1, M1-5, M6-1 INSPECTION FOR THE RETURN OF THE SIGNAL TO CTDOT. ----- EXISTING CONDUIT

3. SEE STAGE 1 TRAFFIC SIGNAL PLAN FOR ADDITIONAL SIGNAL DETAILS.

4. SEE STAGE 2 PLAN FOR SIGN LEGEND FOR SIGNS (1) THROUGH (14).

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* THE NO TURN ON RED BLANK OUT SIGN FOR THE SB RAMP (SIGN I), SHALL BE ACTIVATED FOR PRE-EMPTION PHASE 1 ONLY.

** THE CONTROLLER SHALL USE THE PRE-EMPTION RED TIMES PRIOR TO ENTERING THE PRE-EMPTION PHASE 1.

treet/(*** WHEN ENTERING F	PRE-EMPTION PHASE 1 FACES 1 AND 2 SHALL USE PHASE 2 CLEARANCES.
Maple S	DESIGNER/DRAFTER: THE INFORMATION, INCLUDING ESTIMATED OUANTITIES OF WORK SHOWN ON THESE	JSP RJF BOROUGH OF NAUGATUCK SIGNATURE/ BLOCK: STOCK BLOCK: CONV	MAPLE STREET TOWN: NAUGATUCK 9087-4000 DRAWING NO.
T/16319	SHEETS IS BASED ON LIMITED INVESTIGATIONS BY THE STATE AND IS IN NO WAY WARRANTED TO INDICATE	RJF BOROUGH OF NAUGATUCK DEPARTMENT OF PUBLIC WORKS Of 2/139 Silas Deane Highway Stille 2/12 Rocky Hill CT (80)67-2/336	MAPLE STREET OVER DRAWING TITLE: NAOOATOON DRAWING NO.
rojects/RC rojects/RC 2016	THE CONDITIONS OF ACTUAL QUANTITIES OF WORK WHICH WILL BE REQUIRED. SCALE AS NO	COPPORATED	NAUGATUCK RIVER TEMPORARY SIGNAL PLAN SHEET NO.
P P	REV. DATE REVISION DESCRIPTION SHEET NO. Plotted Date: 1/7/2016	Filename: V:\Projects\RCT\16319 Maple Street\CAD\Highway\16319_temp_signal_sht_02.dgn	STAGE 2 26 of 27

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(N) EXISTING - MAINTAIN KEEP RIGHT

