

## ADDENDUM NO. 4

ROOF REPLACEMENT AND RELATED WORK WESTERN ELEMENTARY SCHOOL NAUGATUCK, CT KBA #15037.00

The following changes to the Project Manual shall become a part of the Drawings, Specifications, Bidding Requirements and Contract Documents; superseding previously issued Drawings, Specifications, Bidding Requirements, Contract Documents and Addenda, to the extent modified by this Addendum.

### **CLARIFICATIONS**

Sketches SKA 4.01 through SKA 4.08 are changes and modifications that are to be incorporated into the bid documents for bidding.

#### **CHANGES TO DRAWINGS**

A3.00 DEMOLITION PLAN See attached SKA 4.01 and SKA 4.02.

A3.01 ROOF PLAN See attached SKA 4.03, SKA 4.04, SKA 4.05 and SKA 4.06.

A3.02 ROOF DETAILS See attached SKA-4.07 and SKA-4.08.


## **ATTACHMENTS**

Sketches:

SKA 4.01, SKA 4.02, SKA 4.03, SKA 4.04, SKA 4.05, SKA 4.06, SKA-4.07 and SKA-4.08.

Date: February 9, 2016

Page: 1 of 1

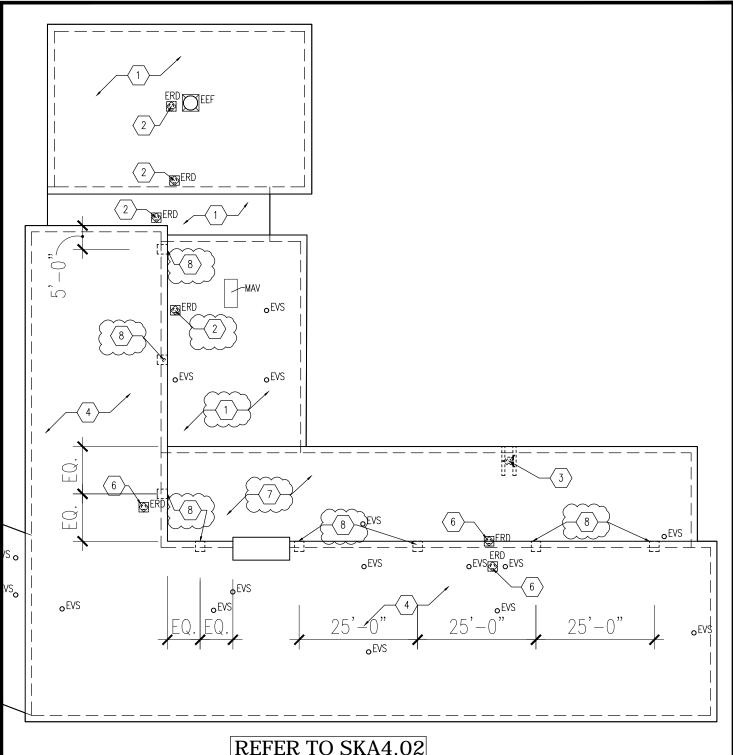

## REFER TO SKA4.02 FOR ADDITIONAL INFORMATION



CONSULTANT:

PROJECT:
ROOF
REPLACEMENT
AT WESTERN
ELEMENTARY
SCHOOL

THIS SKETCH TO
BE READ IN
BE READ IN CONJUNCTION WITH THE
WITH THE
CONTRACT DOCUMENTS
DOCUMENTS

(REVISED) PARTIAL DEMOLITON ROOF PLAN

DATE: 2/9/16 DRAWN: CC DRAWING NO.:

SCALE: N.T.S. PROJECT NO.: 15037.00 SKA4.01

# ROOF DEMOLITION PLAN LEGEND

EEF	EXISTING EXHAUST FAN TO BE REMAIN
₿ERD	EXISTING ROOF DRAIN TO BE REMOVED
<b>o</b> <sup>EVS</sup>	EXISTING VENT STACK
N.P.S.	NOT IN PROJECT SCOPE
{[]	REMOVE 10" WIDE CONCRETE BACK SLOPE

# ROOF DEMOLITION KEY NOTES

1	INDICATED) INCLUDING BUT NOT LIMITED TO: MEMBRANE, MEMBRANE FLASHING, AND INSULATION (TYP).
2	REMOVE EXISTING ROOF DRAIN
3	REMOVE EXISTING ROOF TOP EQUIPMENT
4	ON CONCRETE DECKS REMOVE ALL EXISTING ROOFING MATERIAL DOWN TO AND INCLUDING GRAVEL ON COAL TAR PITCH (WHERE INDICATED) INCLUDING BUT NOT LIMITED TO: MEMBRANE, MEMBRANE FLASHING, AND INSULATION. COAL TAR PITCH TO REMAIN AS MOISTURE BARRIER.
5	REMOVE EXISTING DRAIN BASKET (EXISTING ROOF DRAIN BOWL TO REMAIN).
6	REMOVE EXISTING DRAIN BASKET (EXISTING ROOF DRAIN BOWL TO BE CAPPED).
7	REMOVE ALL EXISTING ROOF MATERIALS DOWN TO CONCRETE DECK, INCLUDING COAL TAR PITCH BUILT UP ROOFING ON 1" OF FIBER GLASS INSULATION.
8	DEMO DOWN TO LEVEL OF CONCRETE DECK 10" WIDE SECTION OF

BOOS s, inc

416 Slater Road, P.O. Box 2590 New Britain, CT 06050-2590 Ph: 860-229-0361 ▲ F: 860-229-5303

325 Foxborough Boulevard, Suite 100 Foxborough, MA 02035 Ph: 508-549-9906 ▲ F: 508-549-9907

> Email: kba@kba-architects.com Web: www.kba-architects.com

CONSULTANT:

PROJECT:

ROOF REPLACEMENT AT WESTERN ELEMENTARY SCHOOL THIS SKETCH TO BE READ IN CONJUNCTION WITH THE CONTRACT DOCUMENTS

SKETCH GENERATED FOR:
ADDENDUM R.R.F.I. A.S.I. P.R.


REFERENCE DETAIL/SHEET: A3.00


REVISED ROOF DEMOLTION LEGEND AND KEY NOTES

DATE: 2/8/16 DRAWN: CC

SCALE: N.T.S. PROJECT NO.: 15037.00 SKA4.02

C.C.D.

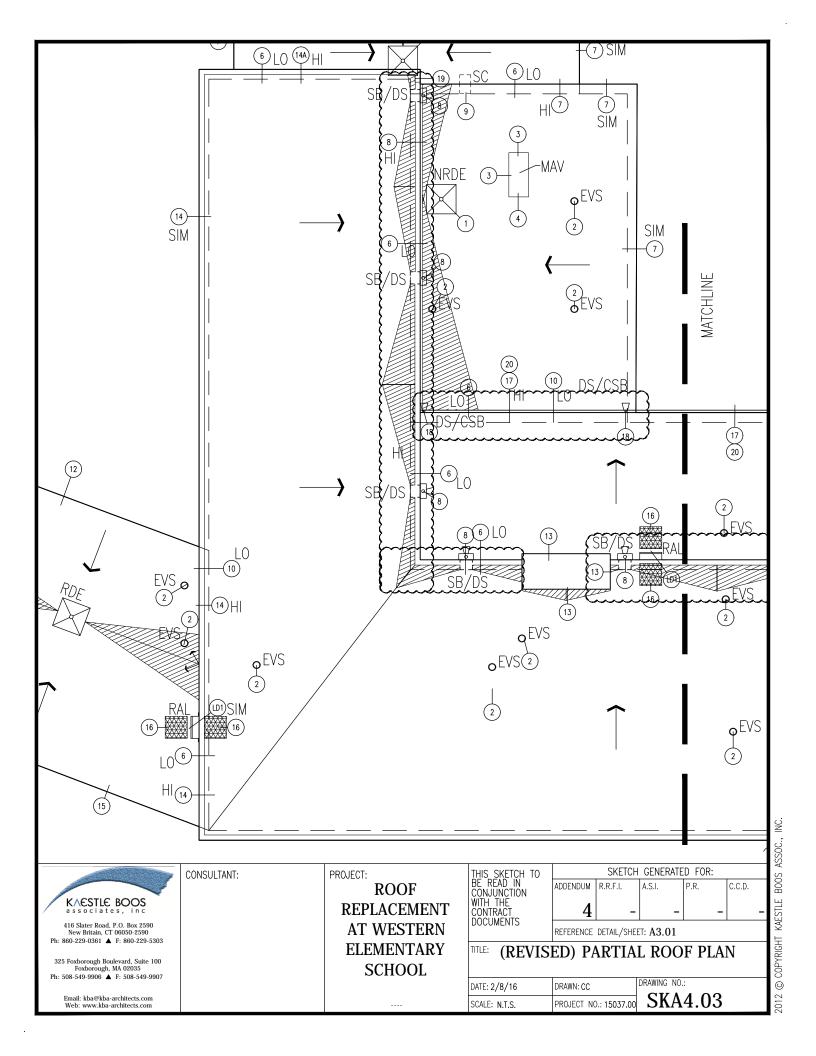

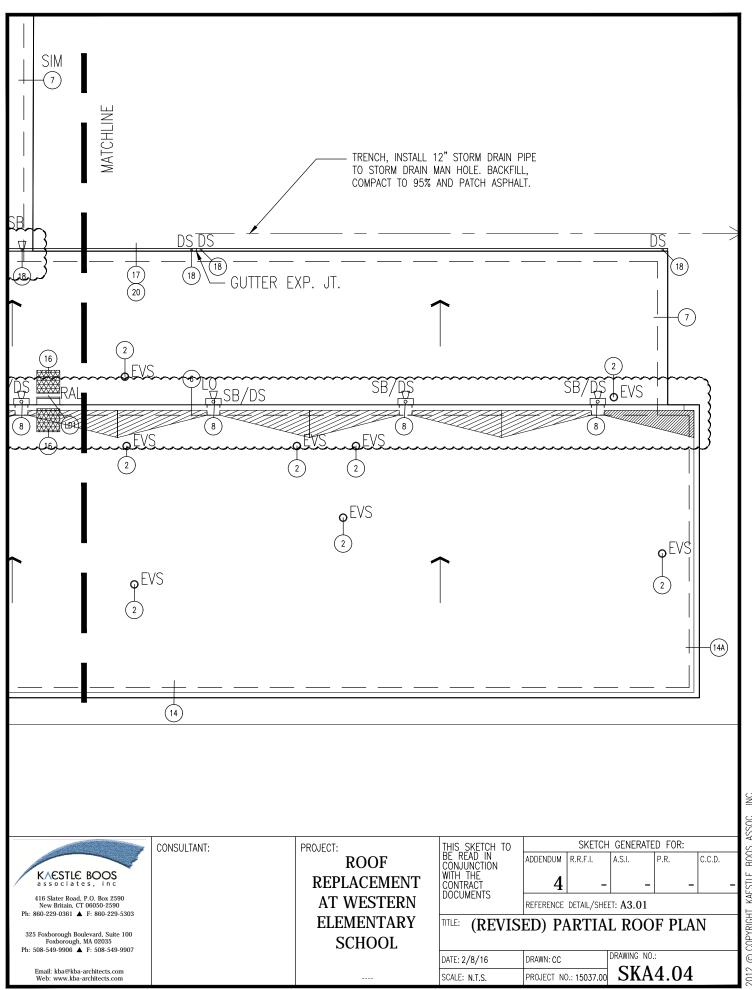

2012 © COPYRIGHT KAESTLE BOOS ASSOC., INC.

## REVISED ROOF GENERAL NOTES #22

IF PLASTER CEILINGS BENEATH CONCRETE DECKS ARE DISTURBED REFER TO ASBESTOS ABATEMENT SPECIFICATIONS FOR REQUIRED PROCEDURES. WHEN WORK IS COMPLETED PAINT AFFECTED AREAS TO MATCH ADJACENT FINISHES.

ADD ROOF GENERAL NOTE #24

ALL REMAINING ACTIVE DRAINS AND PIPES ARE TO 24. BE CLEANED AND SNAKED OUT OF ALL DEBRIS.

## ROOF PLAN LEGEND

AREA OF NEW CRICKET



AREA OF TRAFFIC PAD



EXISTING EXHAUST FAN



NEW ROOF DRAIN & HORIZONTAL PIPING IN NEW LOCATION WITH 4'X4' SUMP



NEW ROOF DRAIN BASKET

AT EXISTING DRAIN LOCATION WITH 4'X4' SUMP



EXISTING VENT STACK



DIRECTION OF ROOF PITCH



NEW ROOF ACCESS LADDER

 $\square$ SC

**SCUPPER** 




**GUTTER & DOWNSPOUT** 

SCUPPER BOX, DOWNSPOUT, & CONCRETE SPLASH BLOCK GUTTER, DOWNSPOUT, & CONCRETE SPLASH BLOCK

# ROOF CONSTRUCTION TYPE KEY PLAN (C)(B) $\mathbb{C}$ $\bigcirc$ (D)

#### ROOF CONSTRUCTION TYPES

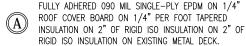

- FULLY ADHERED 090 MIL SINGLE-PLY EPDM ON 1/4" ROOF COVER BOARD ON 1/4" PER FOOT TAPERED (B)INSULATION ON 2" OF RIGID ISO INSULATION ON EXISTING CONC. DECK.
- FULLY ADHERED 090 MIL SINGLE-PLY EPDM ON 1/4" ROOF COVER BOARD ON 1/4" PER FOOT TAPERED INSULATION ON 1 1/2" OF RIGID ISO INSULATION ON EXISTING METAL DEĆK.
- FULLY ADHERED 090 MIL SINGLE-PLY EPDM ON 1/4" ROOF COVER BOARD ON 1/4" PER FOOT TAPERED INSULATION ON 1 1/2" OF RIGID ISO INSULATION ON EXISTING CONC. DEĆK.

## KAESTLE BOOS

416 Slater Road, P.O. Box 2590 New Britain, CT 06050-2590 Ph: 860-229-0361 ▲ F: 860-229-5303

325 Foxborough Boulevard, Suite 100 Foxborough, MA 02035 Ph: 508-549-9906 A F: 508-549-9907

Email: kba@kba-architects.com Web: www.kba-architects.com

CONSULTANT:

## PROJECT:

**ROOF** REPLACEMENT AT WESTERN **ELEMENTARY** SCHOOL

THIS SKETCH	TO
BE READ IN	
CONJUNCTION	
WITH THE	
CONTRACT	
DOCUMENTS	

SKETCH GENERATED FOR: ADDENDUM R.R.F.I. A.S.I. TP.R. leen.

REFERENCE DETAIL/SHEET: A3.01

TITLE: REVISED ROOF KEY PLAN, LEGEND. NOTES, AND CONSTRUCTION TYPES

DATE: 2/8/16	DRAWN: CC
SCALE: N.T.S.	PROJECT NO.: 15037.00

DRAWING NO.: SKA4.05 B00S

AVERAGE R-VALUE CALCULATIONS - ROOF TYPE A EPDM MEMBRANE ON METAL DECK	
OUTSIDE OF AIR VALUE: EPDM MEMBRANE: 1/4" ROOF COVER BOARD: (AVERAGE) INSULATION ASSEMBLY- 5 1/4": EXISTING METAL DECK: INSIDE AIR VALUE:	0.17 0.33 0.28 30.60 0.00 0.61
R-VALUE:	31.99
U-TOTAL (1/R):	0.031

AVERAGE R-VALUE CALCULATIONS - ROOF TYPE C EPDM MEMBRANE ON METAL DECK	
OUTSIDE OF AIR VALUE: EPDM MEMBRANE: 1/4" ROOF COVER BOARD: (AVERAGE) INSULATION ASSEMBLY – 5 1/2": EXISTING METAL DECK: INSIDE AIR VALUE:	0.17 0.33 0.28 31.50 0.00 0.61
R-VALUE:	32.89
U-TOTAL (1/R):	0.030

AVERAGE R-VALUE CALCULATIONS - ROOF TYPE B EPDM MEMBRANE ON CONCRETE DECK	
OUTSIDE OF AIR VALUE: EPDM MEMBRANE: 1/4" ROOF COVER BOARD: (AVERAGE) INSULATION ASSEMBLY - 4 1/2": EXISTING CONCRETE DECK: INSIDE AIR VALUE:	0.17 0.33 0.28 25.60 0.00 0.61
R-VALUE:	26.99
U-TOTAL (1/R):	0.037

AVERAGE R-VALUE CALCULATIONS - ROOF TYPE D EPDM MEMBRANE ON CONCRETE DECK	
OUTSIDE OF AIR VALUE: EPDM MEMBRANE: 1/4" ROOF COVER BOARD: (AVERAGE) INSULATION ASSEMBLY— 5 1/2": EXISTING CONCRETE DECK: INSIDE AIR VALUE:	0.17 0.33 0.28 31.50 0.00 0.61
R-VALUE:	32.89
U-TOTAL (1/R):	0.030

	KAESTLE BOOS
/	associates, inc

416 Slater Road, P.O. Box 2590 New Britain, CT 06050-2590 Ph: 860-229-0361 ▲ F: 860-229-5303

325 Foxborough Boulevard, Suite 100 Foxborough, MA 02035 Ph: 508-549-9906 ▲ F: 508-549-9907

> Email: kba@kba-architects.com Web: www.kba-architects.com

CONSULTANT:

PROJECT:

ROOF REPLACEMENT AT WESTERN ELEMENTARY SCHOOL THIS SKETCH TO BE READ IN CONJUNCTION WITH THE CONTRACT DOCUMENTS

SKETCH GENERATED FOR:

ADDENDUM R.R.F.I. A.S.I. P.R. C.C.D.


REFERENCE DETAIL/SHEET: A3.01

IIILE: NEW AVERAGE R-VALUE CHARTS


DATE: 2/8/16 DRAWN: CC DRAWING NO. SKA

DRAWING NO.:

SKA4.06

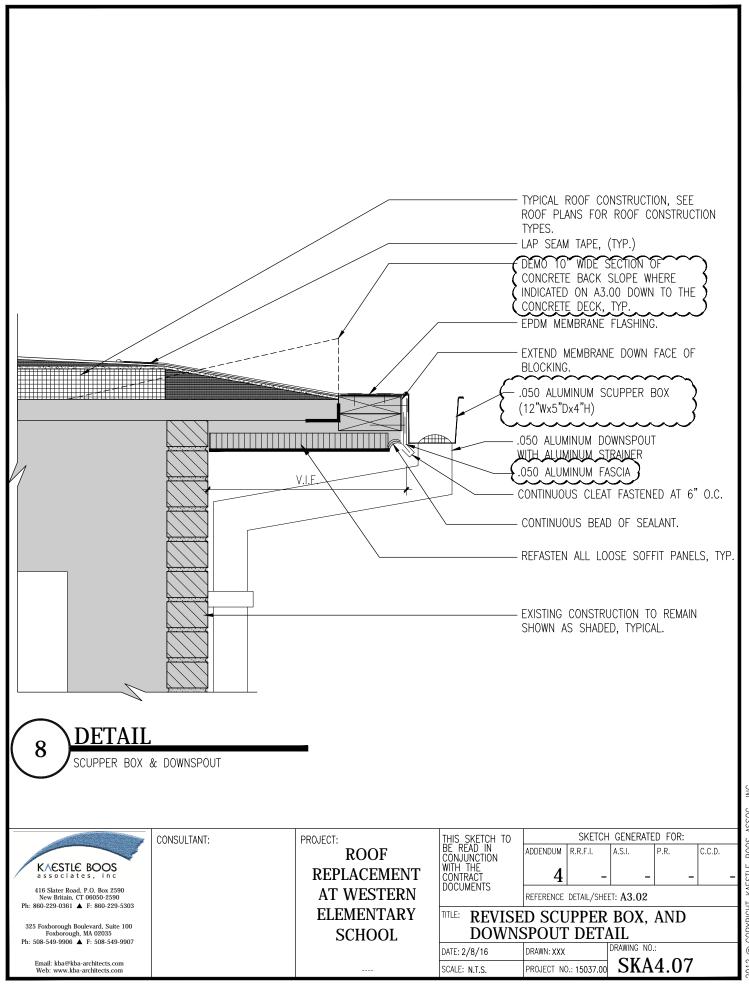

B00S © COPYRIGHT KAESTLE

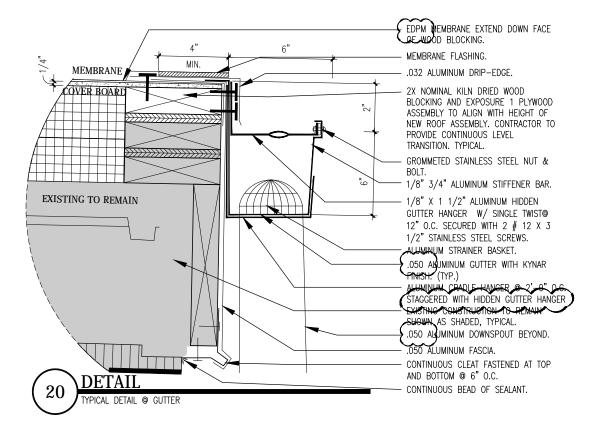

K∧ESTLE BOOS associates, inc 416 Slater Road, P.O. Box 2590 New Britain, CT 06050-2590 Ph: 860-229-0361 ▲ F: 860-229-5303

325 Foxborough Boulevard, Suite 100 Foxborough, MA 02035 Ph: 508-549-9906 ▲ F: 508-549-9907

> Email: kba@kba-architects.com Web: www.kba-architects.com

CONSULTANT:

PROJECT:

ROOF REPLACEMENT AT WESTERN ELEMENTARY SCHOOL THIS SKETCH TO BE READ IN CONJUNCTION WITH THE CONTRACT DOCUMENTS SKETCH GENERATED FOR:

ADDENDUM R.R.F.I. A.S.I. P.R. C.C.D.

REFERENCE DETAIL/SHEET: A3.02

THILE: REVISED DETAIL @ GUTTER

DATE: 2/8/16 DRAWN: CC DRAWING NO.: SCALE: N.T.S. PROJECT NO.: 15037.00 SKA4.08